






Appendix G

Project Plans

Steeno Designs

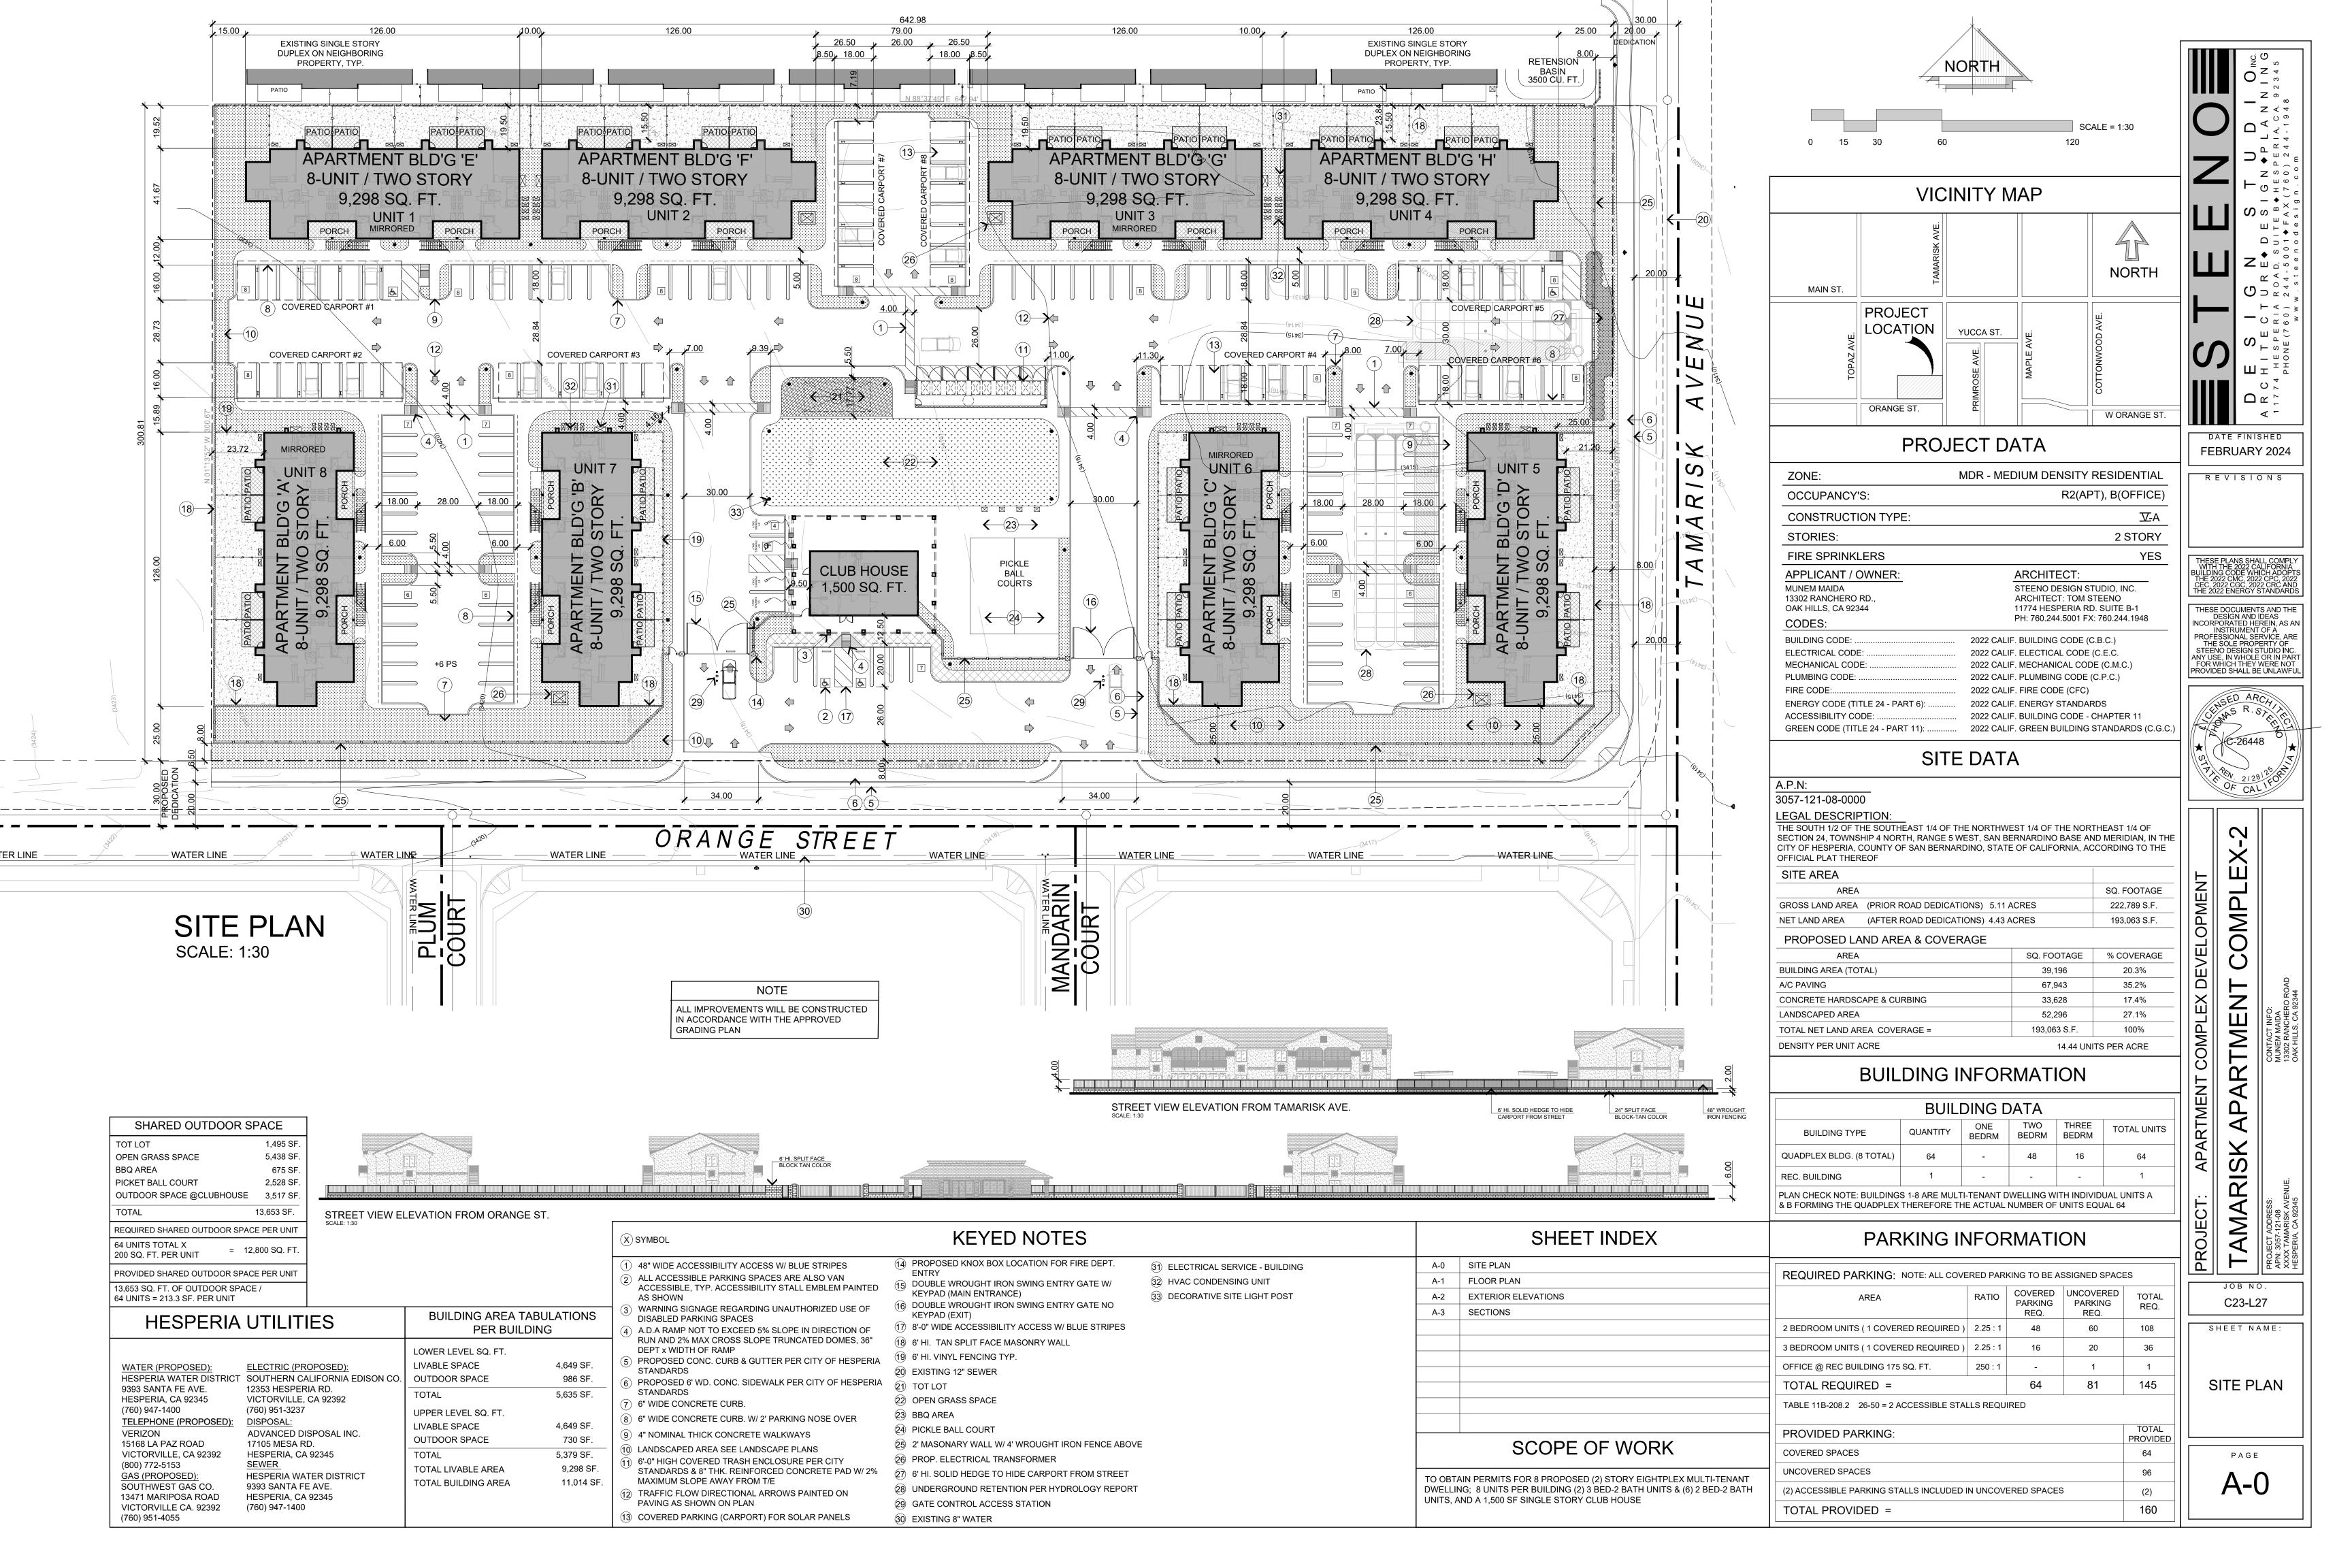

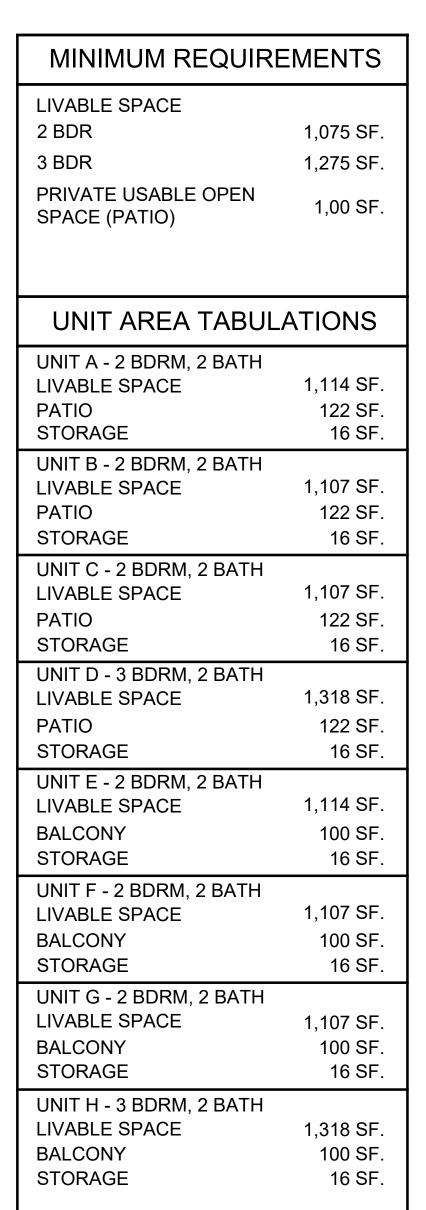

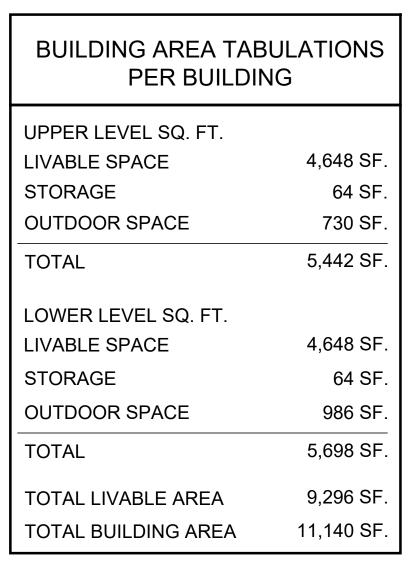



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DATE FINISHED

FEBRUARY 2024

REVISIONS

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COMPLE

**ARTMENT** 

**TAMARISK** 

C21-L25


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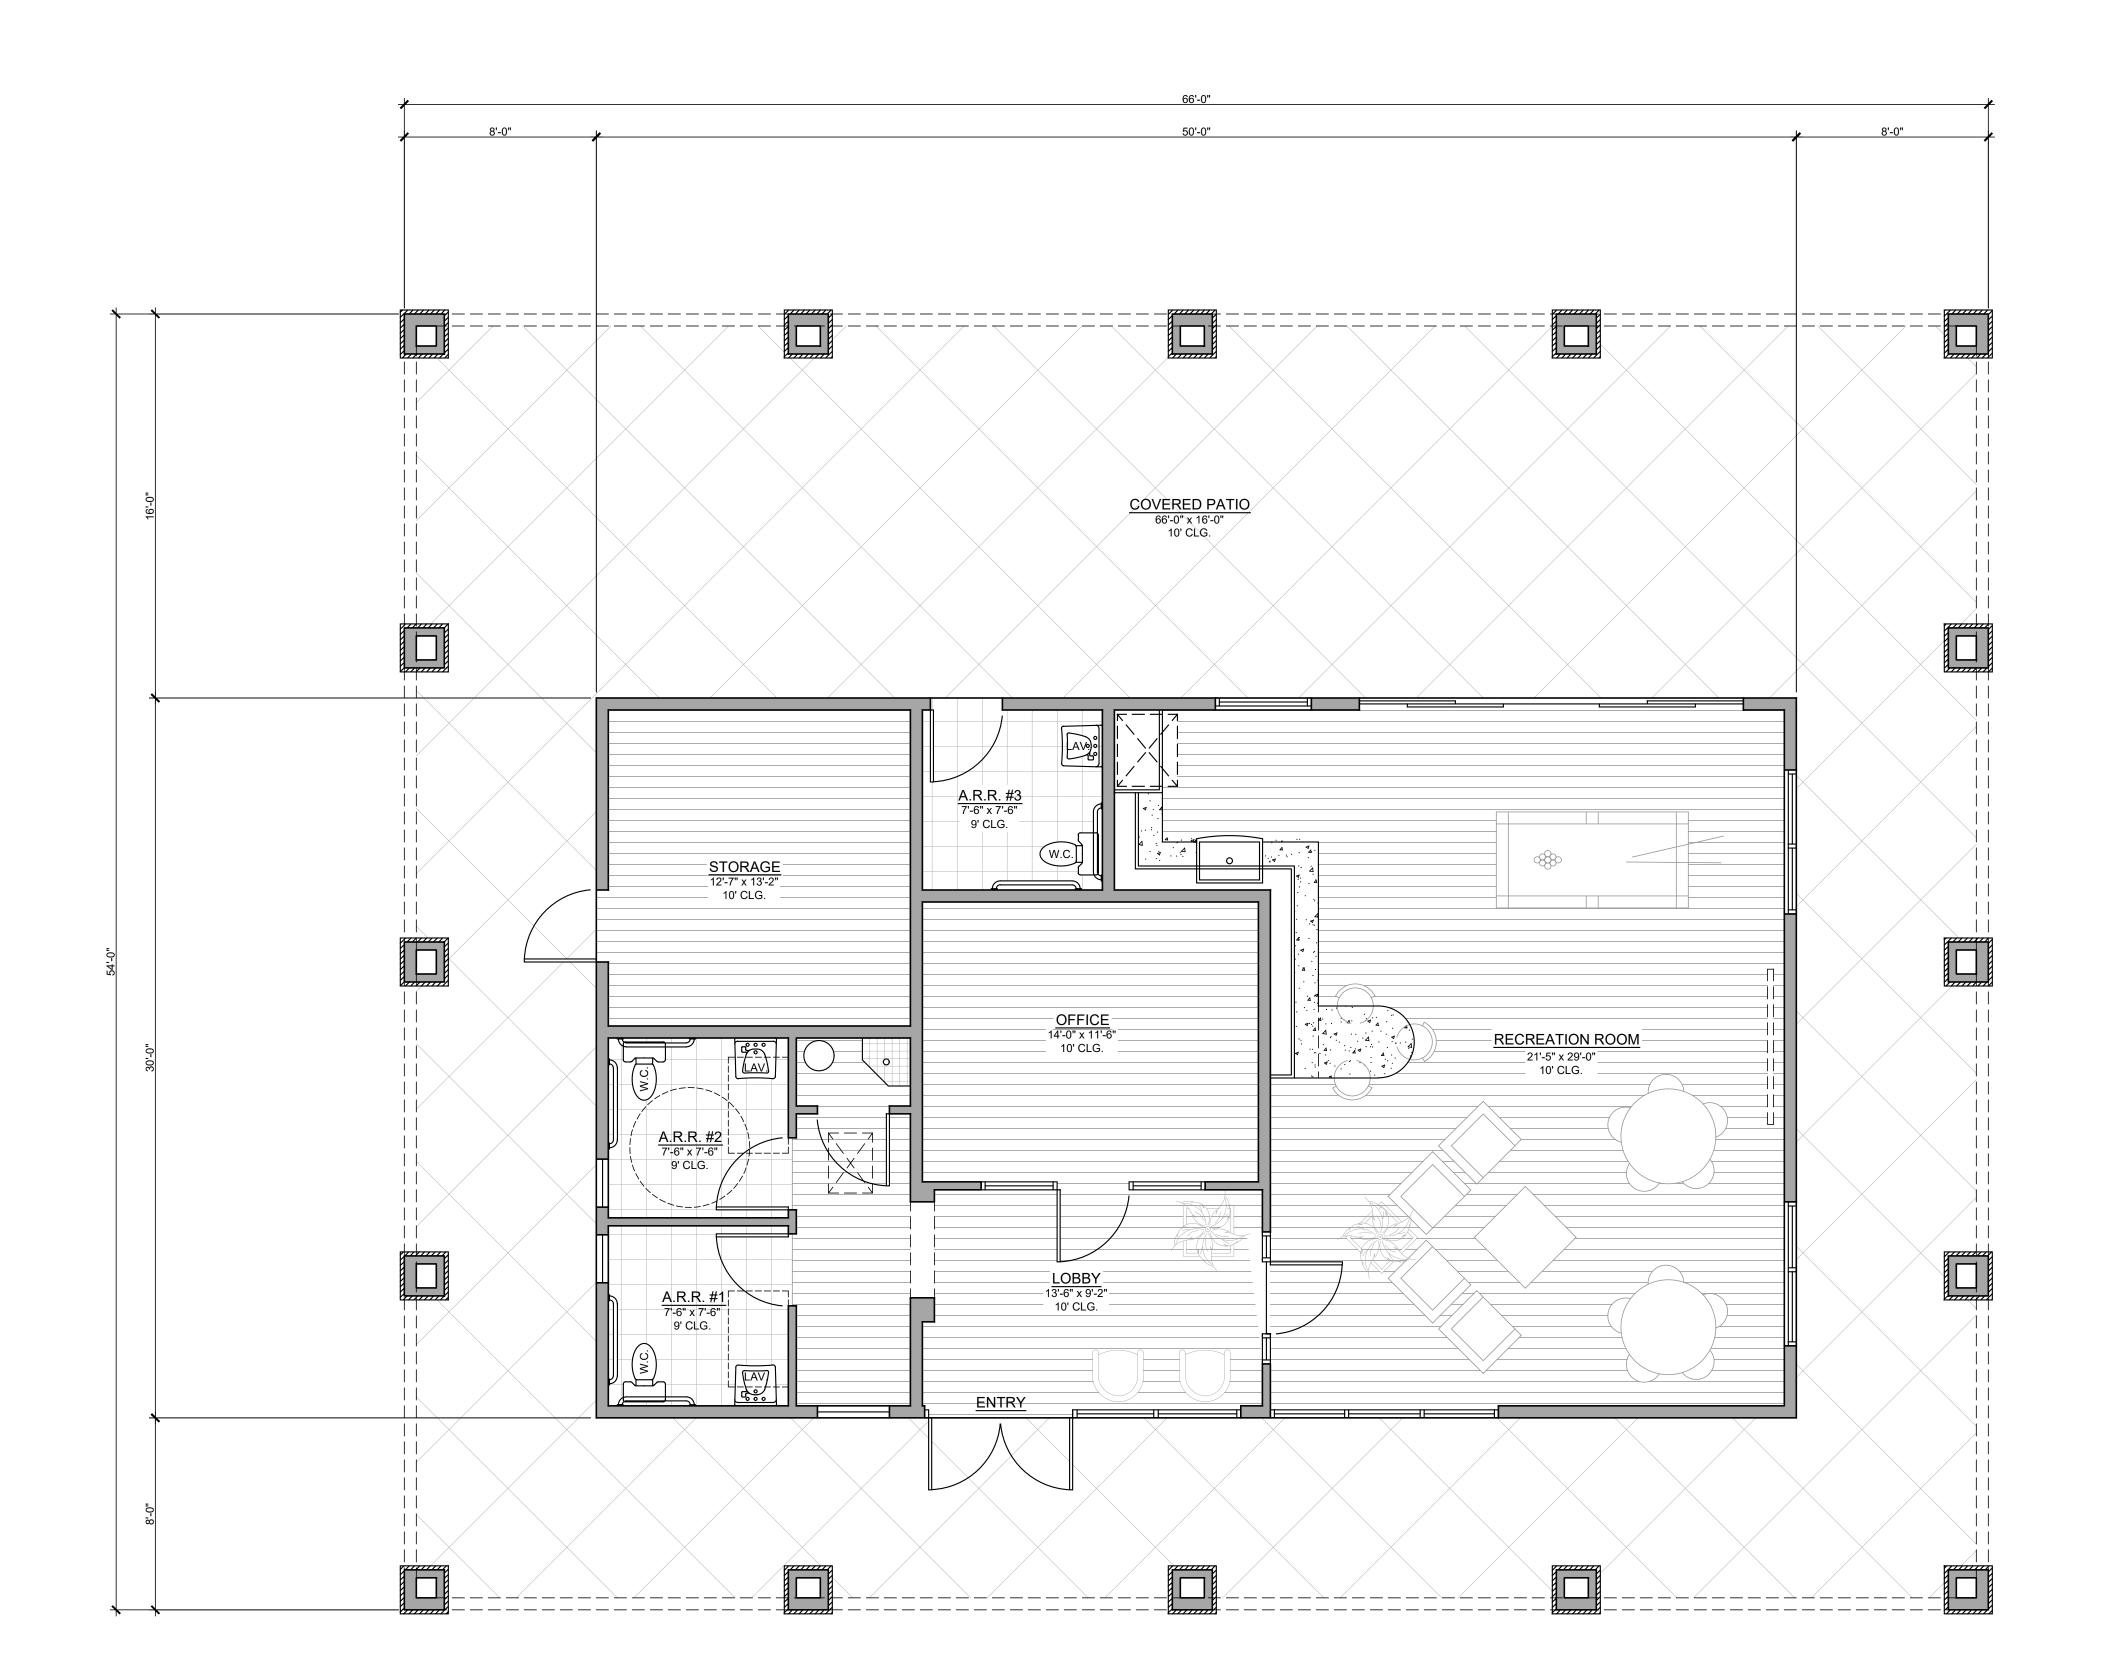
FLOOR PLAN

PAGE

A-1





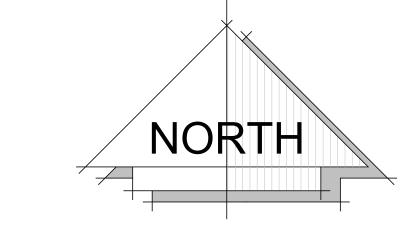

CLUB HOUSE FLOOR PLAN - 1,500 SQ. FT. SCALE: 1/4" = 1'-0"

## CLUB HOUSE

TAMARISK APARTMENT COMPLEX

AREA TABU	LATION
RECREATION ROOM	= 716 SQ.FT.
OFFICE	= 175 SQ.FT.
LOBBY	= 141 SQ. FT
STORAGE	= 186 SQ.FT
A.R.R. 1	= 67 SQ. FT
A.R.R. 2	= 65 SQ.FT.
A.R.R. 3	= 68 SQ.FT.
HALLWAY	= 66 SQ.FT.
JANITOR CLOSET	= 16 SQ.FT.
TOTAL BUILDING	= 1,500 SQ.FT
COVERED PATIO	= 2,064 SQ.FT
GROSS BLDG.	= 3,564 SQ.FT

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JOB NO.

C23-L27

SHEET NAME

FLOOR PLAN


A-1.1



FRONT EXTERIOR ELEVATION
SCALE: 3/16" = 1'-0"



## REAR EXTERIOR ELEVATION SCALE: 3/16" = 1'-0"

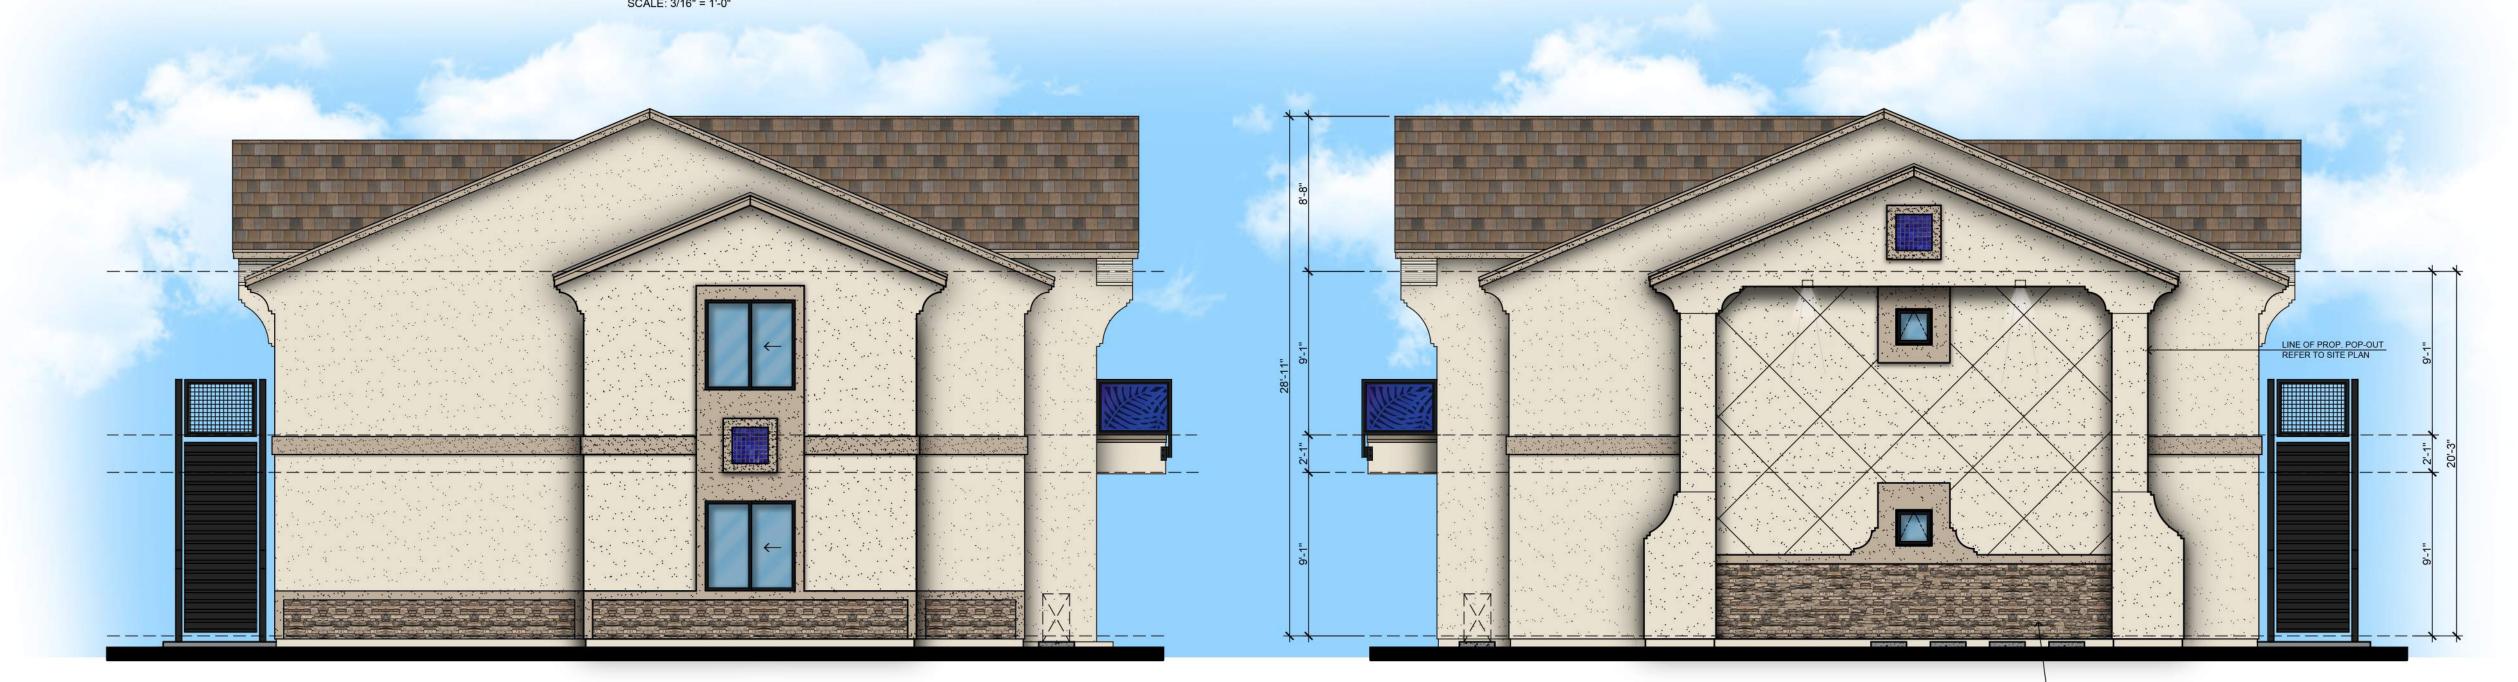

RIGHT EXTERIOR ELEVATION
SCALE: 3/16" = 1'-0"

LEFT EXTERIOR ELEVATION
SCALE: 3/16" = 1'-0"

STONE VENEER W/ 2X6
STUCCOED TRIM

DESIGNAPLANNI

1774 HESPERIA ROAD, SUITE BOHESPERIA, CA. 923

1774 HESPERIA ROAD, SUITE BOHESPERIA, CA. 923

FEBRUARY 2024

REVISIONS

IESE PLANS SHALL COMPLY /ITH THE 2022 CALIFORNIA LDING CODE WHICH ADOPTS E 2022 CMC, 2022 CPC, 2022 C, 2022 CGC, 2022 CRC AND E 2022 ENERGY STANDARDS

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APARTMENT COMPLEX - MULTI STORY - 8 UNIT

SK APARTMENT COMPLEX-2

CONTACT INFO:
MUNEM MAIDA
13302 RANCHERO ROAD

TAMARISK AP.

PROJECT ADDRESS:
APN: 3057-121-08
XXXX TAMARISK AVENUE,
HESPERIA, CA 92345

C21-L25

EXTERIOR ELEVATIONS


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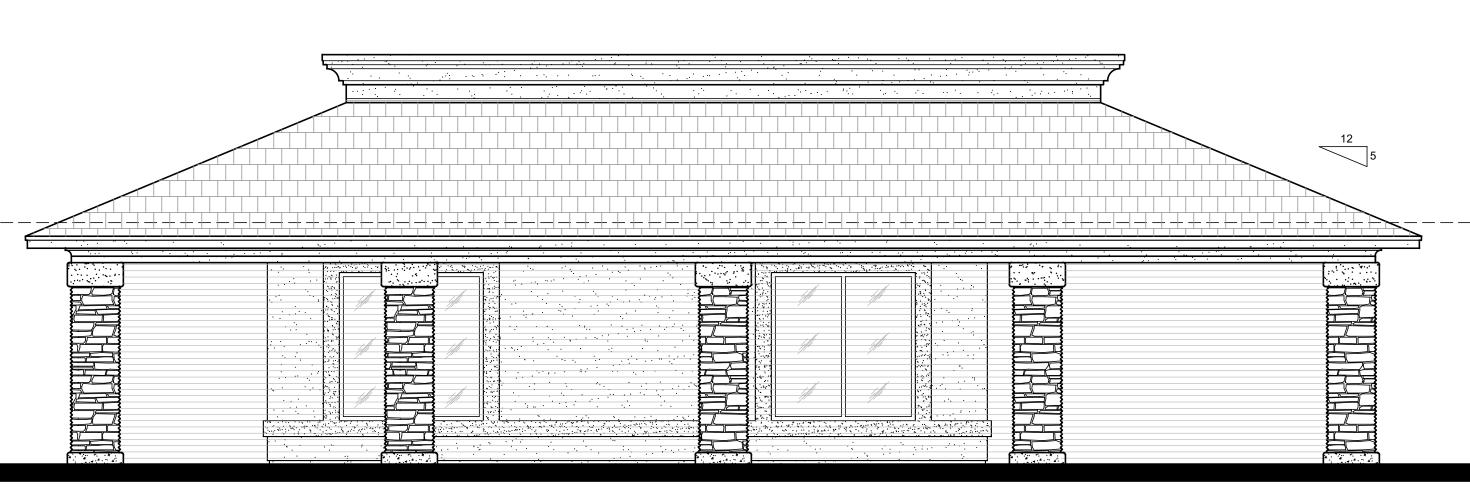


## REAR -NORTH ELEVATION SCALE: 1/4" = 1'-0"



LEFT - WEST ELEVATION

SCALE: 1/4" = 1'-0"

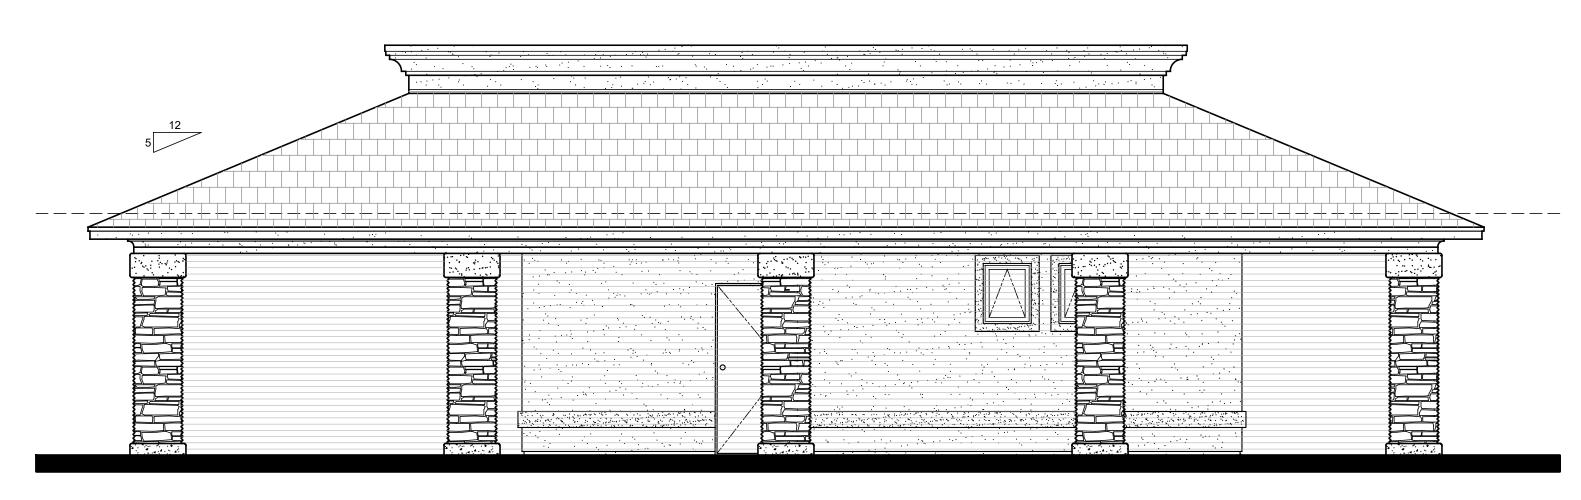

RIGHT - EAST ELEVATION

SCALE: 1/4" = 1'-0"

SHITECTURE, DESIGN, PLANNIN


FEBRUARY 2024

JULY 2024

THESE PLANS SHALL COMPLY
WITH THE 2022 CALIFORNIA
BUILDING CODE WHICH ADOPTS
THE 2022 CMC, 2022 CPC, 2022
CEC, 2022 CGC, 2022 CRC AND
THE 2022 ENERGY STANDARDS

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APARTMENT COMPLEX DEVELOPMENT

CONTACT INFO:
MUNEM MAIDA

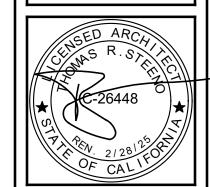PROJECT: APARTMENT COMP

TAMARISK APARTM

PROJECT ADDRESS: CONTACT
APN: 3057-121-08

XXXX TAMARISK AVENUE, HESPERIA, CA 92345
OAK HILLS
OAK HILLS

JOB NO.

C23-L27

EXTERIOR ELEVATIONS

A-2.1


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PROVIDED SHALL BE UNLAWFUL APARTMENT COMPLEX-2

CONTACT INFO:
MUNEM MAIDA
13302 RANCHERO ROAD
OAK HILLS, CA 92344 APARTMENT COMPLEX DEVELOPMENT TAMARISK PROJECT ADDRESS:
APN: 3057-121-08
XXXX TAMARISK AVENUE,
HESPERIA, CA 92345 C23-L27

> CARPORT PLAN/ ELEVATIONS

> > PAGE


ياودts\02 - Commercial\L - P\27 - Maida, Tamarisk Apts 2\93 - CARPORT CD'S\CP-1 Carport\_Tamarisk 2.dwg, 7/10/2024 12:32:4 - مارا

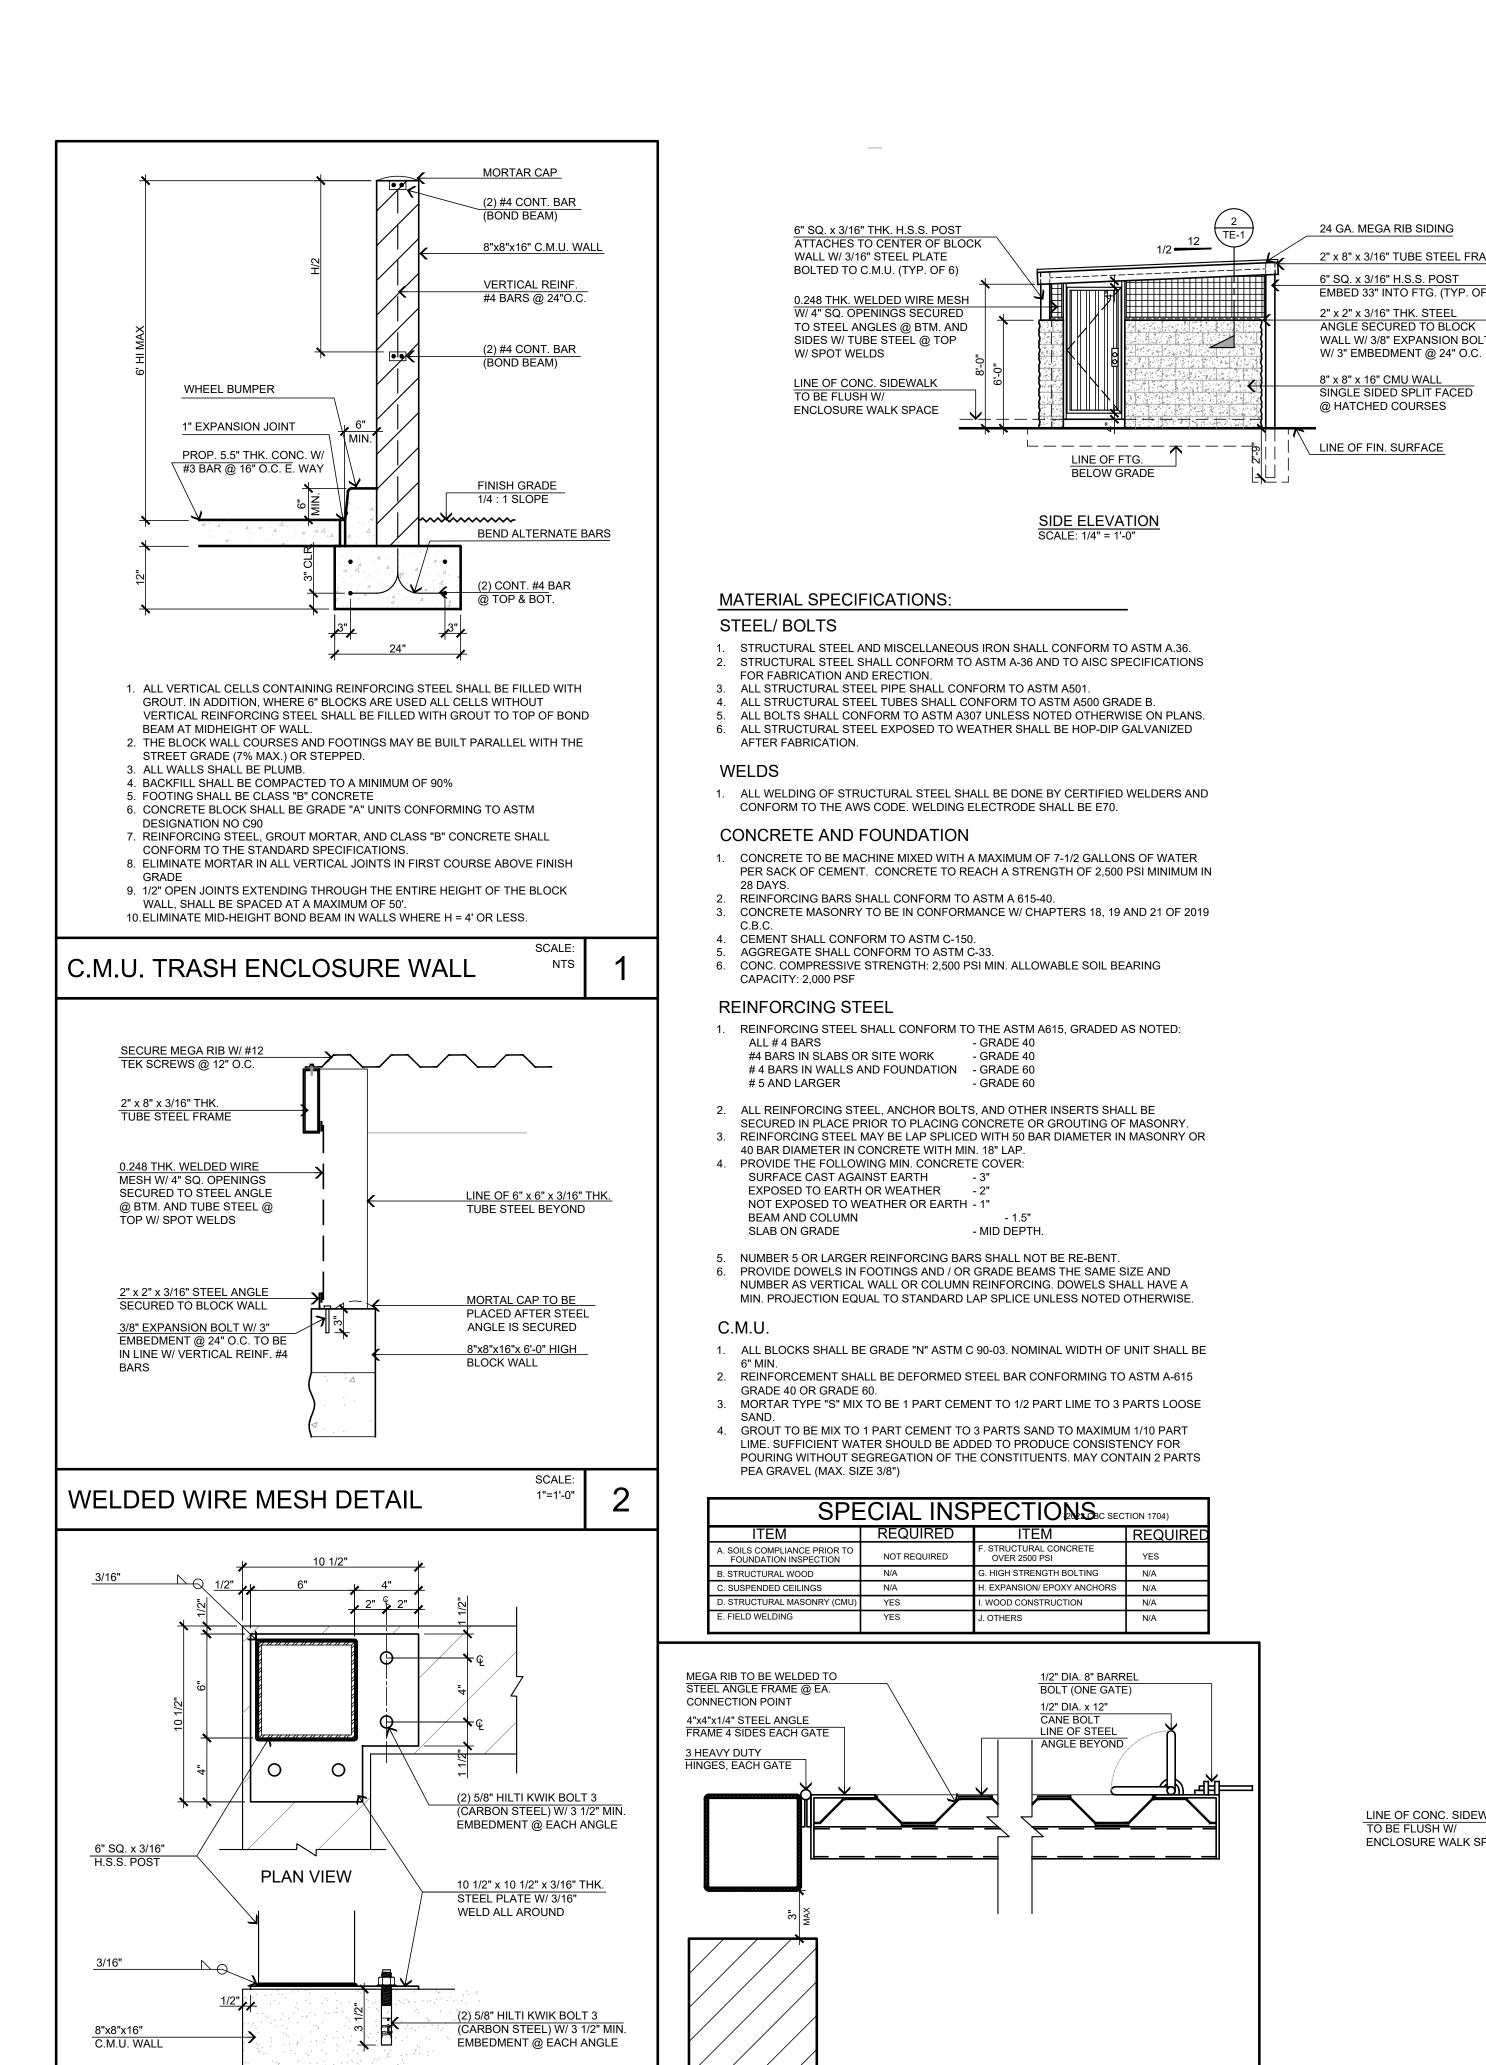

JAMB DETAIL

SCALE:

2"=1'-0"

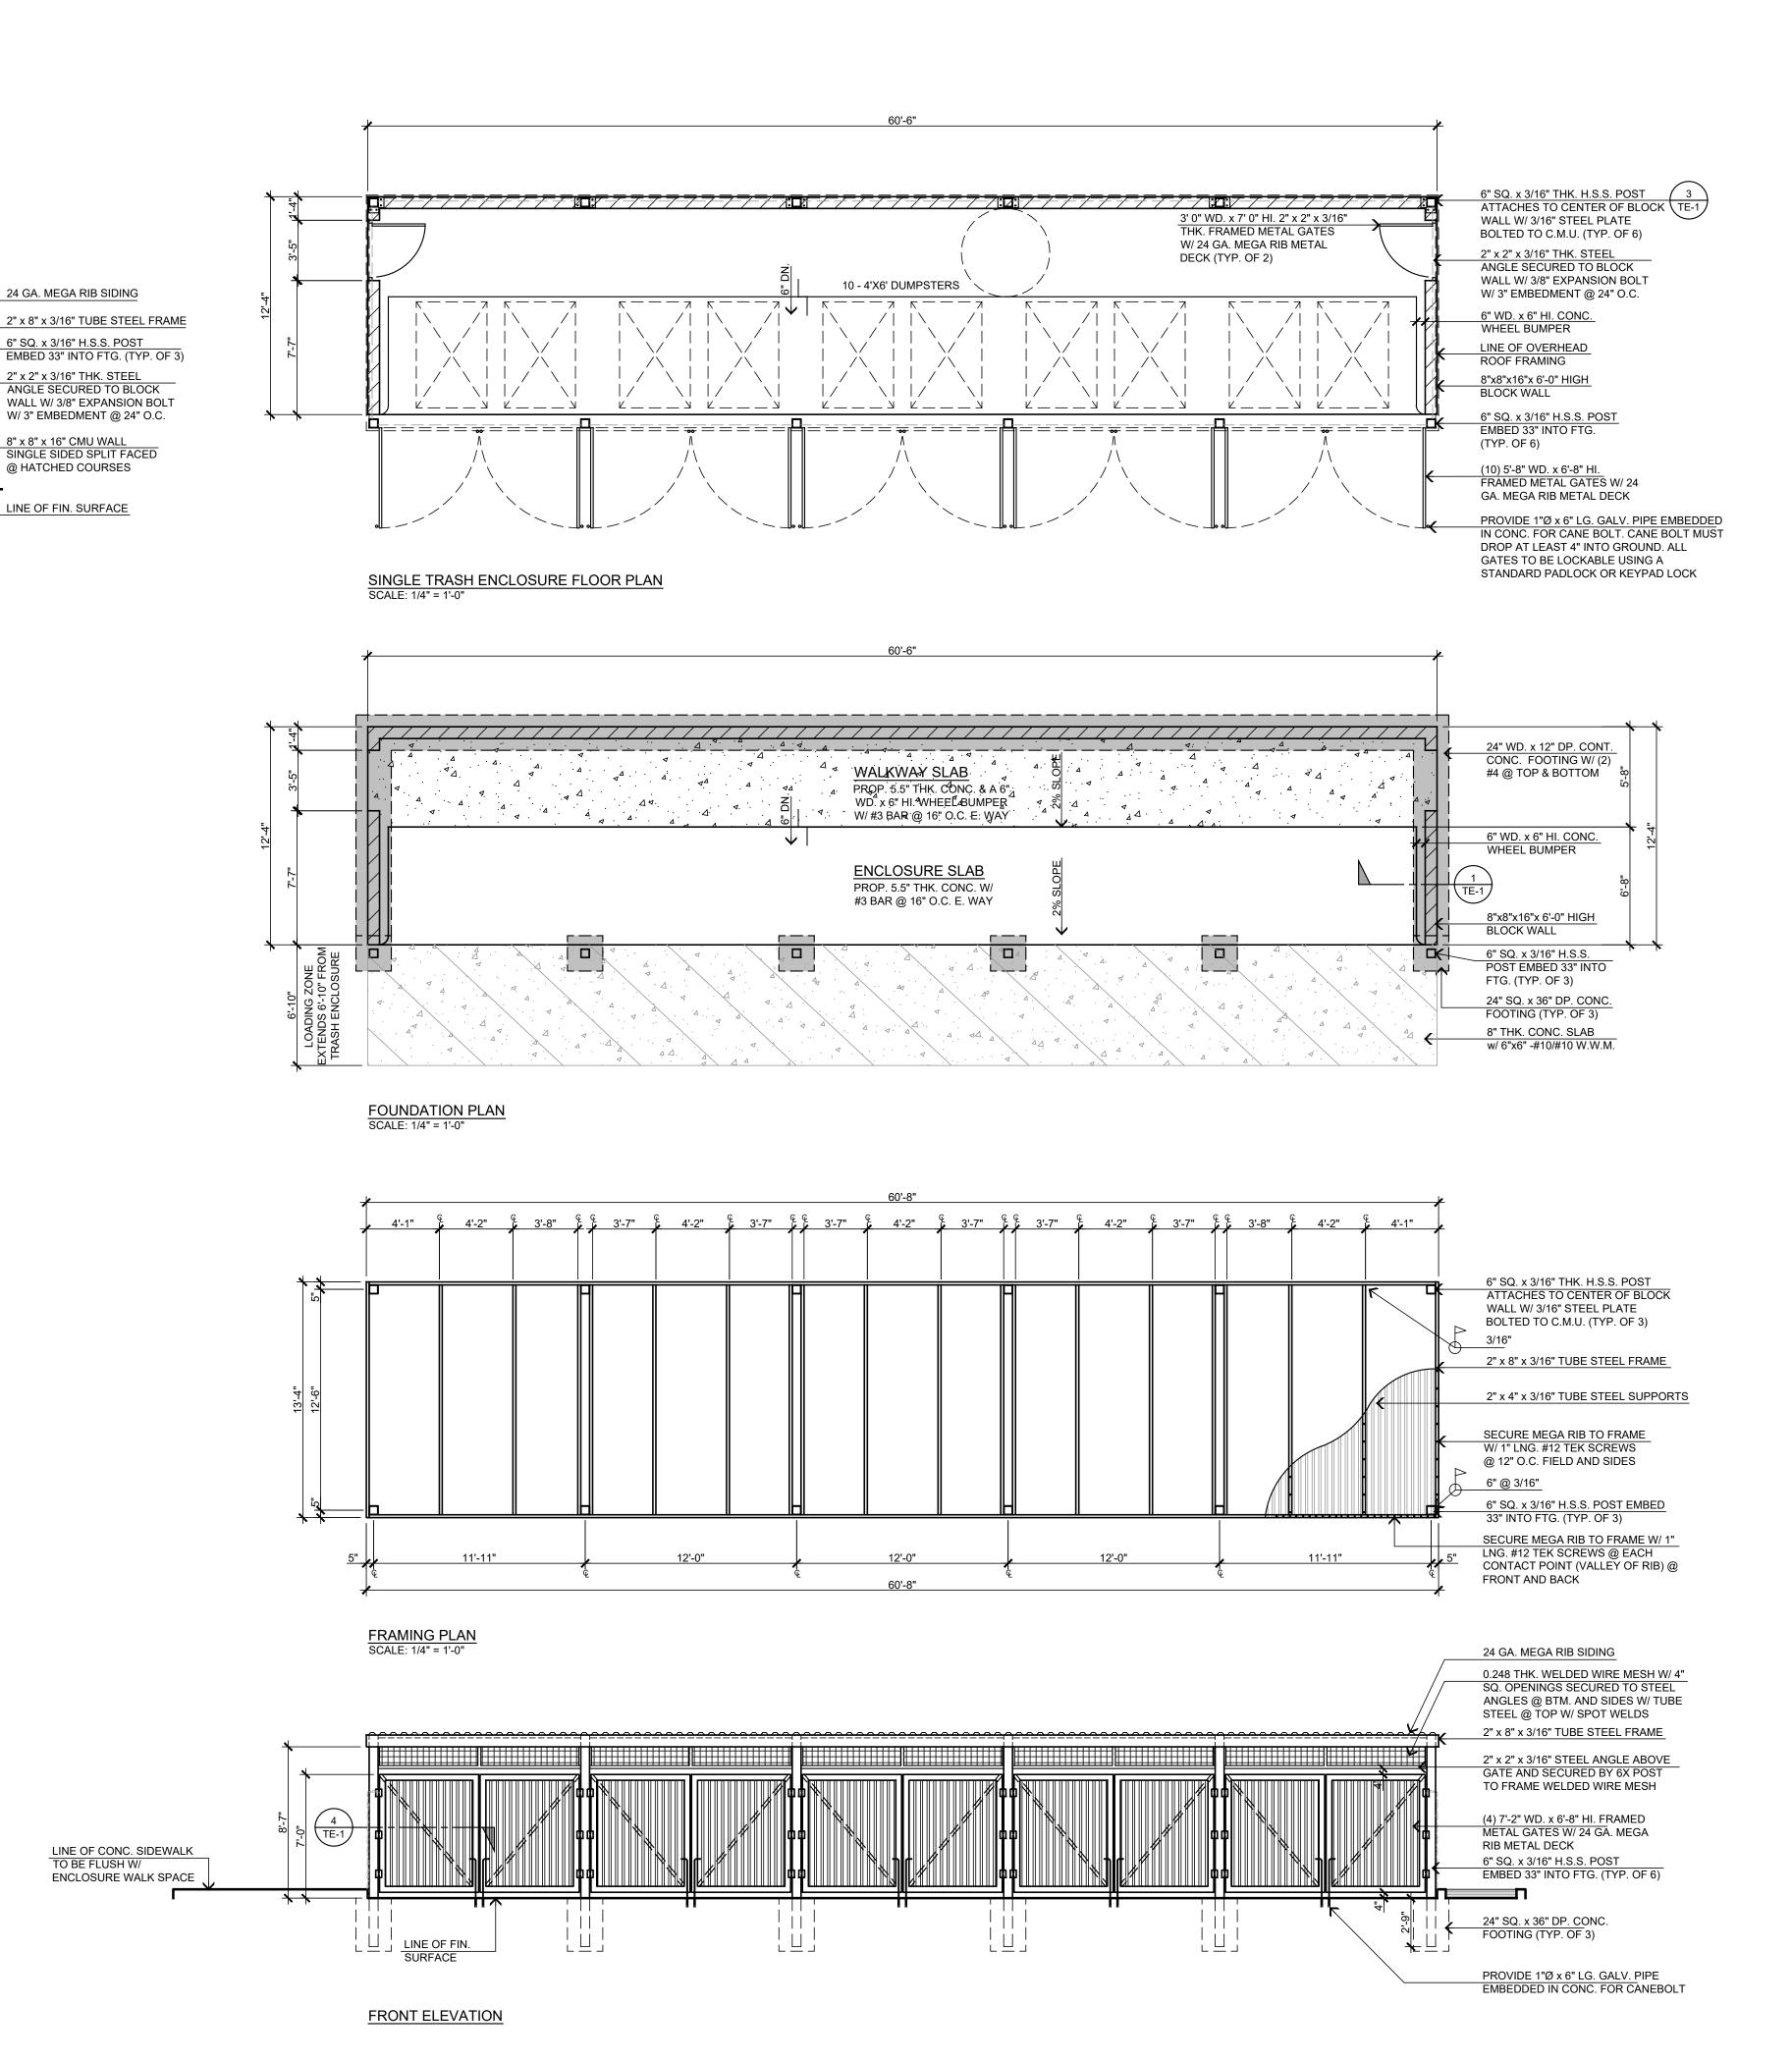

S:\2023 Aprojects\02 - Commercial\L - P\27 - Maida, Tamarisk Apts 2\92 - TRASH ENCLOSURE\TE-1 TRASH ENCLOSURE\_TAMARISK APTS 2.dwg, 7/17/2024 10:22

POST CONNECTION TO C.M.U. DETAIL 2"=1'-0"

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FEBRUARY 2024

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FOR WHICH THEY WERE NOT
PROVIDED SHALL BE UNLAWFUL

OMPL

**APARTMENT** 

TAMARISK PROJECT ADDRESS:
APN: 3057-121-08
XXXX TAMARISK AVENUE,
HESPERIA, CA 92345

ЈОВ МО.

C21-L25

SHEET NAME:

TRASH ENCLOSURE

#### OWNER:

MUNEM MAIDA 13302 RANCHERO ROAD OAK HILLS, CA 92344

#### ARCHITECT:

STEENO DESIGN STUDIO, INC. 11774 HESPERIA ROAD #B2 HESPERIA, CA 92345 (760) 244-5001

## **ENGINEER:**

HIGH DESERT MAPPING 16704 NEENACH ROAD APPLE VALLEY, CA 92307

RAYMOND J. ALLARD, RCE 36052

## LEGAL DESCRIPTION:

THE S 1/2, SE 1/4, NW 1/4, NE 1/4, SECTION 24, T4N, R5W. S.B.M.

#### **UTILITY SUPPLIERS:**

HESPERIA WATER DISTRICT 9700 SEVENTH AVENUE HESPERIA, CA 92345 (760) 947-1840 CITY OF HESPERIA PUBLIC WORKS 9700 SEVENTH AVENUE HESPERIA, CA 92345 (760) 947-1400 SOUTHERN CALIFORNIA EDISON 16938 BEAR VALLEY ROAD VICTORVILLE, CA (760) 241-3805 TELEPHONE \_\_\_ 15055 LA PAZ DRIVE VICTORVILLE, CA \_ CHARTER COMMUNICATIONS VICTORVILLE, CA TRASH SERVICE \_\_\_ ADVANCE DISPOSAL CO. 17150 MESA STREET HESPERIA, CA 92345 (760) 244-9773

SOUTHWEST GAS CORPORATION

13471 MARIPOSA ROAD VICTORVILLE, CA (760) 245-9321

## LIST OF DRAWINGS:


1	TITLE SHEET	. T-1
2	NOTES & DETAILS	N-1
3	TAMARISK AVENUE IMPROVEMENT PLAN	ST-
4	ORANGE STREET IMPROVEMENT PLAN	ST-
5	GRADING PLAN (WEST)	. G-1
6	GRADING PLAN (EAST)	G-2
7	UTILITY PLAN	. U-1
8	DETAILS	D-1
9	DETAILS	D-2
10	DETAILS	D-3
11	STORMTECH DETAILS (BED 1)	SD-
12	STORMTECH DETAILS (BED 2)	SD-
13	CROSS SECTIONS	. CS-


## **ESTIMATED EARTHWORK:**

CUT: 1,700 CU. YDS FILL: 5,420 CU. YDS.

## TAMARISK APARTMENTS

## APN 3057-121-08 TAMARISK AVENUE HESPERIA, CA 92345

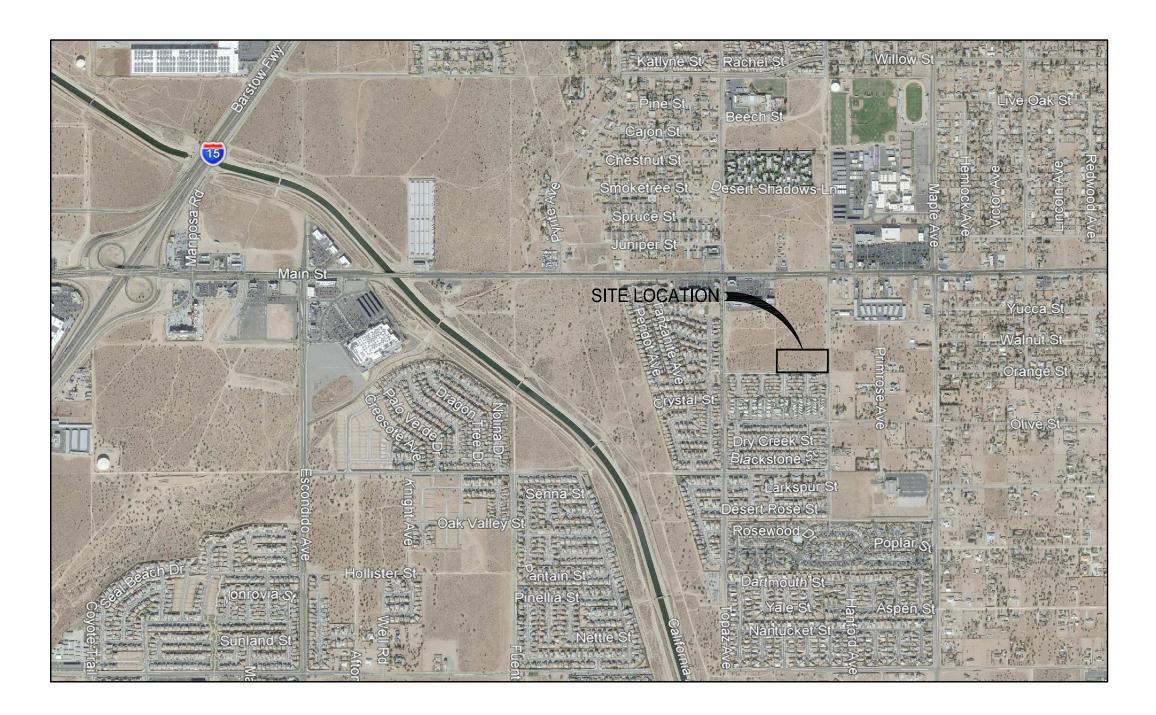

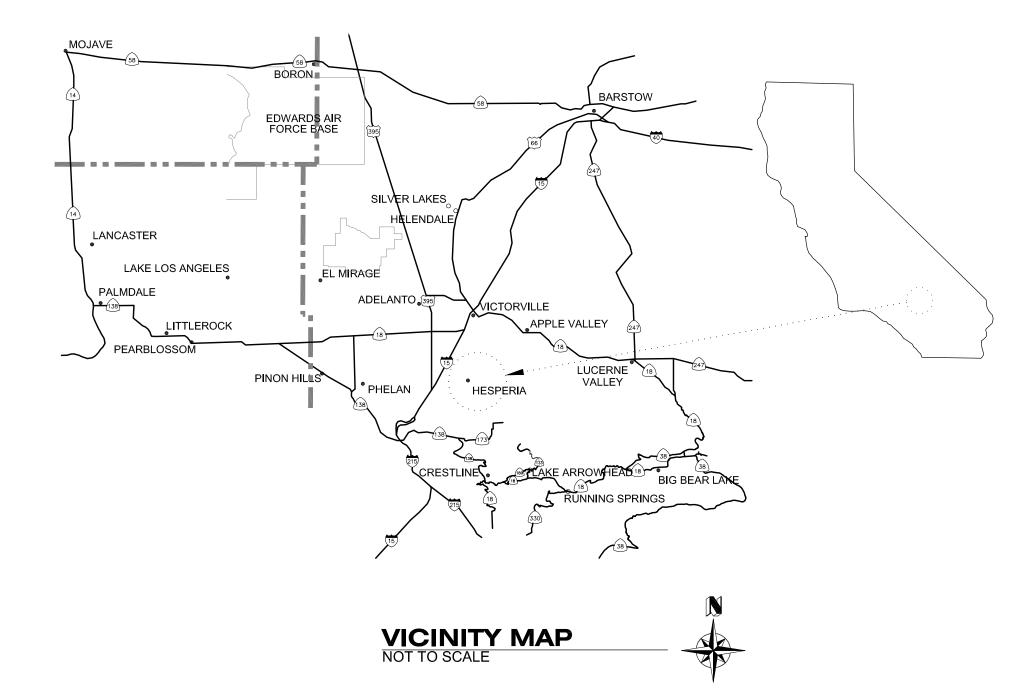



LOCATION MAP NOT TO SCALE

## LEGEND:

INDICATES PAD ELEVATION INDICATES FINISHED FLOOR ELEVATION INDICATES TOP OF CURB INDICATES FINISHED SURFACE ELEVATION INDICATES FLOWLINE ELEVATION INDICATES HIGH POINT INDICATES GRADE BREAK INDICATES TOP OF GRATE INDICATES INVERT ELEVATION INDICATES TOP OF WALL INDICATES TOP OF FOOTING INDICATES EXISTING ELEVATION INDICATES EXISTING 1-FOOT CONTOUR INDICATES EXISTING 5-FOOT CONTOUR INDICATES EXISTING POWER POLE INDICATES EXISTING GUY WIRE INDICATES EXISTING JOSHUA TREE INDICATES PROPOSED FLOWLINE INDICATES PROPOSED A.C. PAVEMENT

INDICATES EXISTING IMPROVEMENTS TO BE REMOVED

## DECLARATION OF ENGINEER OF RECORD

I HEREBY DECLARE THAT IN MY PROFESSIONAL OPINION, THE DESIGN OF THE IMPROVEMENTS AS SHOWN ON THESE PLANS COMPLIES WITH THE CURRENT PROFESSIONAL ENGINEERING STANDARDS AND PRACTICES. AS THE ENGINEER IN RESPONSIBLE CHARGE OF THE DESIGN OF THESE IMPROVEMENTS, I ACCEPT FULL RESPONSIBILITY FOR SUCH DESIGN. I UNDERSTAND AND ACKNOWLEDGE THAT THE LIMITED PURPOSE OF ENSURING THAT THESE PLAN COMPLY WITH CITY PROCEDURES AND OTHER APPLICABLE CODES AND ORDINANCES. THE PLAN REVIEW PROCESS IS NOT A DETERMINATION OF THE TECHNICAL ADEQUACY OF THE DESIGN OF THE IMPROVEMENTS. SUCH PLAN CHECK DOES NOT THEREFORE RELIEVE ME OF MY DESIGN

LICENSE No. 36052

R.C.E. <u>74776</u> EXP. DATE <u>12/31/25</u>

**CITY ENGINEER** 



## Know what's below. Call before you dig.

REV.	DESCRIPTION DATE	BY	

**BENCHMARK:** 

BRASS DISK IN CONCRETE, LOCATED APPROXIMATELY 22 FEET NORTH OF THE NE ECR, BEHIND THE SIDEWALK AT THE INTERSECTION OF MAIN ST. & MAPLE ELEV=3376.492

DESIGNED BY: D.B.W. \_\_D.B.W. DRAWN BY: CHECKED BY: R.J.A. SUBMITTED BY:

RAYMOND J. ALLARD RCE No. 36052



DATE

## HIGH DESERT MAPPING

Land Surveying - Civil Design 16704 Neenach Road Apple Valley, CA 92307

(760) 508-8555

dbw.hdm@gmail.com

2. 0	
	HESPERIA IG DEPARTMENT
RECOMMENDED FOR APPROVAL BY:	APPROVED BY:
DATE	CASSANDRA SANCHEZ DATE

**AUTHORIZED SIGNATURE** 

## **CITY OF HESPERIA** TITLE SHEET TAMARISK APARTMENTS

**MUNEM MAIDA** APN 3057-121-08

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#### **GENERAL CONSTRUCTION NOTES**

- 1. ALL WORK SHALL BE DONE IN ACCORDANCE WITH THESE PLANS AND THE CITY OF HESPERIA STANDARDS AND SPECIFICATIONS.
- 2. PRIOR TO CONSTRUCTION, THE CONTRACTOR SHALL CONTACT ALL UTILITY COMPANIES TO DETERMINE THE EXACT LOCATION OF ALL UNDERGROUND FACILITIES WHETHER SHOWN OR NOT SHOWN. IT SHALL BE THE CONTRACTOR'S RESPONSIBILITY TO PROTECT ALL EXISTING FACILITIES FROM DAMAGE DURING CONSTRUCTION.
- 3. CALL UNDERGROUND SERVICE ALERT TWO WORKING DAYS BEFORE ANY TRENCHING, ETC. AT 811. THE FOLLOWING AGENCIES SHALL BE CONTACTED BEFORE ANY CONSTRUCTION OR EXCAVATION BEGINS.

HESPERIA WATER DISTRICT (760) 947-1840 CITY OF HESPERIA PUBLIC WORKS DEPT (760) 947-1400 (760) 947-1500 CITY OF HESPERIA POLICE DEPT (760) 947-1641 CITY OF HESPERIA FIRE PREVENTION SOUTHWEST GAS CORP. (760) 241-9321 VERIZON TELEPHONE (800) 483-3000 VERIZON FIBER OPTIC (800) 248-0133 CHARTER COMMUNICATIONS (866) 499-8080 (800) 684-8123 SOUTHERN CALIFORNIA EDISON UNDERGROUND SERVICE ALERT POST OFFICE (760) 244-3897 HESPERIA SCHOOL DISTRICT (760) 244-4411 VICTOR VALLEY TRANSIT (760) 948-4021 ADVANCED DISPOSAL (760) 244-9773

- 4. THE CONTRACTOR IS RESPONSIBLE FOR THE COORDINATION OF THE REMOVAL OR RELOCATION OF ANY AND ALL EXISTING UTILITIES WITH THE RESPECTIVE UTILITY COMPANY. COST OF THIS COORDINATION IS TO BE INCLUDED IN THE PRICE BID FOR THE VARIOUS IMPROVEMENTS TO COMPLETE THE PROJECT.
- 5. A CERTIFICATE OF COMPACTION SIGNED BY A REGISTERED ENGINEER SHALL BE SUBMITTED FOR ALL TRENCH BACKFILLS.
- 6. THE CONTRACTOR SHALL BE HELD RESPONSIBLE FOR ANY FIELD CHANGES MADE WITHOUT PRIOR WRITTEN AUTHORIZATION FROM THE UNDERSIGNED ENGINEER, DEVELOPER AND THE CITY OF HESPERIA.
- 7. THE CONTRACTOR IS RESPONSIBLE FOR PROTECTING ALL SURVEY MONUMENTS. ANY SURVEY MONUMENTS DISTURBED DURING THE COURSE OF CONSTRUCTION SHALL BE REPLACED BY A LICENSED SURVEYOR AND AT THE CONTRACTOR'S EXPENSE.
- 8. THE CONTRACTOR AGREES THAT HE SHALL ASSUME SOLE AND COMPLETE RESPONSIBILITY FOR JOB SITE CONDITIONS DURING THE COURSE OF CONSTRUCTION OF THIS PROJECT. INCLUDING SAFETY OF ALL PERSONS AND PROPERTY; THAT THIS REQUIREMENT SHALL APPLY CONTINUALLY AND NOT BE LIMITED TO NORMAL WORKING HOURS; AND THAT THE CONTRACTOR SHALL DEFEND, INDEMNIFY AND HOLD THE OWNER AND THE ENGINEER HARMLESS FROM ANY AND ALL LIABILITY, REAL OR ALLEGED, IN CONNECTION WITH THE PERFORMANCE OF WORK ON THIS PROJECT EXCEPTING FOR LIABILITY ARISING FROM THE SOLE NEGLIGENCE OF THE OWNER OR THE ENGINEER.
- 9. AN ENCROACHMENT PERMIT FROM THE CITY OF HESPERIA SHALL BE OBTAINED PRIOR TO THE BEGINNING OF ANY WORK OR CONSTRUCTION WITHIN THE STREET RIGHT-OF-WAY.
- ADEQUATE STAKING SHALL BE SET BY THE ENGINEER OF RECORD OR LICENSED SURVEYOR TO ENABLE THE CONTRACTOR TO CONSTRUCT IMPROVEMENTS PER THE SIGNED IMPROVEMENT PLANS.
- 11. ALL STATIONING IS BASED ON THE CENTER LINE OF THE STREET.
- 12. ALL EXCAVATIONS SHALL BE BACKFILLED AT THE END OF EACH WORKING DAY AND ROADS OPEN TO VEHICULAR TRAFFIC UNLESS OTHERWISE APPROVED BY THE CITY ENGINEER.
- 13. ALL TRAFFIC CONTROL SHALL BE PER 2012 CA. M.U.T.C.D. "MANUAL OF UNIFORM TRAFFIC CONTROL DEVICES".
- 14. THE ENGINEER OF RECORD SIGNING THESE PLANS IS RESPONSIBLE FOR THE ACCURACTY AND ACCEPTABILITY OF THE WORK.
  THE ENGINEER OF RECORD IS REQUIRED TO STAMP AND SIGN THE "DECLARATION OF ENGINEER OF RECORD" HEREON.
- 15. CULTURAL RESOURCES: IF CULTURAL RESOURCES ARE FOUND DURING GRADING THEN GRADING ACTIVITIES SHALL CEASE AND THE APPLICANT SHALL CONTRACT WITH A CITY APPROVED ARCHAEOLOGIST OR PALEONTOLOGIST TO MONITOR GRADING PRIOR TO RESUMING GRADING. ALL CULTURAL RESOURCES DISCOVERED SHALL BE HANDLED IN ACCORDANCE WITH STATE AND FEDERAL LAW. A REPORT OF ALL RESOURCES DISCOVERED AS WELL AS THE ACTIONS TAKEN SHALL BE PROVIDED TO THE CITY PRIOR TO ISSUANCE OF A CERTIFICATE OF OCCUPANCY.

## **GRADING PLANS NOTES**

Know what's below.

Call before you dig

- 1. ALL GRADING SHALL CONFORM TO CHAPTER 15.06 OF THE CITY OF HESPERIA MUNICIPAL CODE.
- 2. ALL PROVISIONS OF THE PRELIMINARY SOILS REPORT PREPARED BY: ALR ENGINEERING & TESTING PROJECT NUMBER 1711356, DATED DECEMBER 20, 2017, SHALL BE COMPLIED WITH DURING GRADING OPERATIONS.
- 3. THIS PLAN IS FOR GRADING PURPOSES ONLY. APPROVAL OF THIS PLAN DOES NOT CONSTITUTE APPROVAL OF DRIVEWAY LOCATIONS OR SIZES, PARKING LOT LAYOUT, BUILDING LOCATIONS, OFFSITE DRAINAGE FACILITIES OR OTHER ITEMS NOT RELATED DIRECTLY TO THE BASIC GRADING OPERATIONS.
- 4. CERTIFICATION FROM THE ENGINEER OF RECORD STATING THAT THE GRADING HAS BEEN COMPLETED PER THE APPROVED PLAN AND THE COMPACTION REPORT FROM THE SOILS ENGINEER ON ANY FILL AREAS THAT ARE REQUIRED SHALL BE PROVIDED PRIOR TO BUILDING PERMITS BEING ISSUED.
- 5. CONTRACTOR IS RESPONSIBLE FOR EROSION. DUST, AND DRAINAGE CONTROL PER SWPPP AND NPDES CRITERIA UNTIL PROJECT COMPLETION.
- 6. ANY ONSITE RETAINING WALLS SHOWN ON THIS PLAN THAT ARE UNDER THREE (3) FEET IN HEIGHT AND SUPPORT A SURCHARGE OR THAT ARE OVER THREE (3) FEET IN HEIGHT REQUIRE SEPARATE REVIEW AND APPROVAL FROM THE BUILDING OFFICIAL AT (760) 947-1300. ANY NECESSARY RETAINING WALLS ON THE PERIMETER OF THIS SITE SHALL BE IN PLACE AND APPROVED BY THE BUILDING OFFICIAL PRIOR TO THE START OF GRADING. APPROVED SEQUENCED GRADING WITH 1-1/2:1 MAXIMUM SLOPES TO WITHIN TWO (2) FEET OF THE ADJACENT PROPERTY LINE MAY BE ACCEPTABLE TO ALLOW FOR START OF GRADING PRIOR TO COMPLETION OF ANY NECESSARY PERIMETER RETAINING WALLS
- 7. ANY IMPROVEMENTS CONSTRUCTED IN THE PUBLIC RIGHT-OF-WAY WILL REQUIRE SEPARATE PLAN APPROVAL, ENCROACHMENT PERMIT, AND INSPECTION FROM THE ENGINEERING OFFICE AT (760) 947-1477.
- 8. ANY WALLS, FENCES, STRUCTURES AND / OR APPURTENANCES ADJACENT TO THIS PROJECT SHALL BE PROTECTED IN PLACE. IF GRADING OPERATIONS DAMAGE OR ADVERSELY AFFECT SAID ITEMS IN ANY WAY, THE CONTRACTOR AND/OR DEVELOPER ARE RESPONSIBLE FOR WORKING OUT AN ACCEPTABLE SOLUTION TO THE SATISFACTION OF THE AFFECTED PROPERTY OWNER(S).
- 9. THE CONTRACTOR AND / OR DEVELOPER ARE RESPONSIBLE FOR ENSURING THAT RETAINING WALLS DO NOT INTERFERE WITH PROVISION OF UTILITIES.
- 10. IT IS THE SOILS ENGINEER'S RESPONSIBILITY TO ENSURE THAT ADEQUATE COMPACTION HAS BEEN ATTAINED ON THE ENTIRE GRADING SITE, INCLUDING FILL AREAS OUTSIDE THE BUILDING PADS AND ON ALL FILL SLOPES.
- 11. IT SHALL BE THE CONTRACTOR'S RESPONSIBILITY TO CALL THE BUILDING AND SAFETY DEPARTMENT AT (760) 947-1300 FOR INSPECTION TWO (2) WORKING DAYS PRIOR TO PERFORMING ANY WORK. WORK PERFORMED WITHOUT CALLING FOR INSPECTION SHALL BE REJECTED AND SHALL BE REMOVED SOLELY AT THE CONTRACTOR'S EXPENSE.

## STREETS AND STORM DRAIN NOTES


- ALL WORK SHALL BE DONE IN ACCORDANCE WITH THESE PLANS AND THE 2012 CA. M.U.T.C.D. "MANUAL ON UNIFORM TRAFFIC CONTROL DEVICES" AND S.P.P.W.C. "GREEN BOOK" STANDARD PLANS AND SPECIFICATIONS TOGETHER WITH ANY MODIFICATIONS THERETO ADOPTED BY THE CITY OF HESPERIA.
- 2. IT SHALL BE THE RESPONSIBILITY OF THE CONTRACTOR TO FAMILIARIZE HIMSELF WITH THE JOB SITE AND THE LOCATION OF ALL UNDERGROUND FACILITIES SHOWN OR NOT SHOWN ON THESE PLANS. NEITHER THE CITY OF HESPERIA NOR THE CITY ENGINEER WILL BE RESPONSIBLE FOR ANY DAMAGE TO UNDERGROUND FACILITIES.
- 3. IT SHALL BE THE CONTRACTOR'S RESPONSIBILITY TO OBTAIN ALL NECESSARY PERMITS.
- 4. IT SHALL BE THE CONTRACTOR'S RESPONSIBILITY TO CALL THE CITY ENGINEERING OFFICE AT (760) 947-1477 FOR INSPECTION 24 HOURS PRIOR TO PERFORMING ANY WORK. WORK PERFORMED WITHOUT CALLING FOR INSPECTION SHALL BE REJECTED AND SHALL BE REMOVED SOLELY AT THE CONTRACTOR'S EXPENSE.
- 5. UTILITY CONTRACTORS SHALL BE RESPONSIBLE OR OBTAINING COMPACTION TESTS OF ALL TRENCH BACKFILL AND STREET SUBGRADES AND SUBMITTING THEM TO THE CITY ENGINEERING OFFICE. NOTIFY THE CITY ENGINEERING OFFICE AT (760) 947-1477 24 HOURS PRIOR TO TEST.
- 6. THE STRUCTURAL SECTIONS SHOWN ON THESE PLANS ARE BASED ON R-VALUE TESTS OR CITY MINIMUM STRUCTURAL STANDARDS, WHICHEVER IS GREATER. IN THE EVENT FIELD CONDITIONS VARY FROM INITIAL TEST RESULTS, ADDITIONAL TESTS, MATERIAL REPORTS AND REVISED STRUCTURAL SECTIONS MAY BE REQUIRED TO BE PREPARED AND SUBMITTED BY THE PROJECT ENGINEER OF RECORD TO THE ENGINEERING OFFICE FOR REVIEW AND EVALUATION. APPROVAL WILL BE GIVEN WHEN ALL STRUCTURAL SECTION REQUIREMENTS HAVE BEEN MET. R-VALUE TESTS ARE REQUIRED AND SHALL BE SUBMITTED IN ALL CASES. STRUCTURAL SECTIONS SHALL BE DESIGNED IN ACCORDANCE WITH CALTRANS HIGHWAY DESIGN MANUAL CHAPTER 600.
- 7. STAKING CUT SHEETS SHALL BE PREPARED BY THE DEVELOPER'S ENGINEER AND SUBMITTED TO THE CITY ENGINEERING OFFICE. NO CONSTRUCTION SHALL BE ALLOWED PRIOR TO THE CITY ENGINEER'S APPROVAL OF THE CUT SHEETS.
- 8. THE CONTRACTOR SHALL VERIFY THAT ESTIMATED QUANTITIES SHOWN ARE CORRECT BEFORE BIDDING ON ANY ITEM.
- 9. THE CONTRACTOR SHALL MAINTAIN DUST CONTROL AT ALL TIMES.
- 10. ALL EXISTING PAVEMENT TO BE REMOVED SHALL BE SAWCUT OR WHEELCUT AND REMOVED TO CLEAN STRAIGHT LINES PER THE CITY INSPECTOR.
- 11. AT ALL LOCATIONS WHERE NEW PAVEMENT JOINS EXISTING, THE EXISTING PAVEMENT SHALL BE COATED WITH AN ASPHALTIC EMULSION.
- 12. THE CONTRACTOR IS RESPONSIBLE FOR THE PROTECTION OF ALL UTILITY VALVES, BOXES AND COVERS, AND ADJUSTING OF ALL UTILITY VALVE BOXES AND COVERS TO FINISH GRADE.
- 13. THE CONTRACTOR SHALL SET MANHOLE RINGS PER CITY STANDARDS.
- 14. THE CONTRACTOR SHALL CALL IN A LOCATION REQUEST TO UNDERGROUND SERVICE ALERT (USA) PHONE NUMBER 811, TWO WORKING DAYS BEFORE DIGGING. NO INSPECTION WILL BE PROVIDED BY THE CITY ENGINEER'S OFFICE AND NO CONSTRUCTION PERMIT ISSUED INVOLVING EXCAVATION FOR UNDERGROUND FACILITIES WILL BE VALID UNLESS THE APPLICANT HAS BEEN PROVIDED AN INQUIRY IDENTIFICATION NUMBER BY USA
- 15. CITY APPROVAL OF PLANS DOES NOT RELIEVE THE DEVELOPER FROM THE RESPONSIBILITY FOR THE CORRECTION OF ERRORS AND OMISSIONS DISCOVERED DURING CONSTRUCTION. UPON REQUEST, THE REQUIRED PLAN REVISIONS SHALL BE PROMPTLY SUBMITTED TO THE CITY ENGINEER FOR APPROVAL.
- 16. CONTRACTOR IS RESPONSIBLE FOR PROVIDING A TRAFFIC CONTROL PLAN TO BE REVIEWED AND APPROVED BY THE CITY ENGINEER PRIOR TO CONSTRUCTION. ALL TRAFFIC CONTROL SHALL BE PER 2012 CA. M.U.T.C.D. "MANUAL ON UNIFORM TRAFFIC CONTROL DEVICES".
- 17. ALL UTILITIES OR SUBSTRUCTURES OF ANY KIND, AND TELEPHONE POWER POLES, WATER METERS, VALVES, HYDRANTS, ETC., SHOWN OR NOT SHOWN ON THESE PLANS WITHIN THE LIMITS OF THIS DEVELOPMENT OR IN ADJACENT AREAS WHERE IMPROVEMENT WORK IS TO BE DONE SHALL BE REMOVED OR RELOCATED AT DEVELOPER'S EXPENSE, AND AT NO COST TO THE CITY OF HESPERIA. IT SHALL BE THE OWNER'S RESPONSIBILITY TO NOTIFY ALL AGENCIES CONCERNED.
- 18. ALL CONSTRUCTION TO BE IN CONFORMANCE WITH THE REGULATIONS OF CAL-OSHA.

#### WATER LINE INSTALLATION

- 1. MATERIALS AND INSTALLATION SHALL CONFORM TO THE CITY OF HESPERIA STANDARDS AND CURRENT MATERIALS LIST
- 2. IT IS THE CONTRACTOR'S RESPONSIBILITY TO MAINTAIN A CURRENT AND APPROVED SET OF CITY OF HESPERIA STANDARDS AND MATERIALS LIST ON THE JOB SITE AT ALL TIMES. CITY STANDARDS AND MATERIAL LISTS ARE AVAILABLE AT THE CITY OF HESPERIA ENGINEERING DEPARTMENT.
- 3. DISTRIBUTION WATER MAINS SHALL HAVE A MINIMUM OF 48" OF COVER FOR 8" MAIN AND 42" MINIMUM COVER FOR 12" AND LARGER MAINS FROM TOP OF PIPE TO FINAL GRADE. TRANSMISSION WATER MAINS SHALL HAVE A MINIMUM OF 72" OF COVER. RECLAIMED WATER MAINS SHALL HAVE A MINIMUM OF 60" OF COVER.
- 4. HYDRO TEST AT 200 PSI MINIMUM FOR 2 HOUR DURATION AT LOWEST POINT IN THE WATER LINE.
- 5. SERVICE LINES TO BE INSTALLED PER STANDARD DWG. W-7.
- 6. METERS SHALL BE PLACED WITHIN 2 FEET MINIMUM, 5 FEET MAXIMUM, FROM ADJACENT PROPERTY LINE. METER BOXES IN THE SIDEWALK SHALL BE IN TRAFFIC RATED BOXES.
- 7. 14 GUAGE COPPER COATED WIRE TO BE TAPED TO TOP OF PIPE. ALL SPLICES TO BE MADE WITH 3M CONNECTORS.
- 8. ALL NEW FIRE HYDRANTS INSTALLED ARE TO BE COVERED AT TIME OF INSTALLATION, UNTIL THE WATER LINE IS ACTIVATED.
- 9. RESILIENT WEDGE VALVES TO BE MUELLER, AFC, CLOW OR AMERICAN AVK WITH SS STEM AND BUTTERFLY VALVES TO BE MUELLER OR PRATT AS PER CITY OF HESPERIA STANDARDS.
- 10. ALL NEW FIRE HYDRANTS SHALL BE MUELLER, AFC AMERICAN DARLING, CLOW OR AMERICAN AVK #2780 WITH (1) 4" NOZZLE, (2) 2-1/2" NOZZLES AND 5-1/4" MINIMUM VALVE OPENINGS, AS PER CITY OF HESPERIA STANDARDS AND MATERIALS LIST.
- 11. ALL VALVES INSTALLED BY THE CONTRACTOR SHALL BE ACCESSIBLE FOR OPERATION WITH COMPLETE VALVE CAN TO GRADE DIRECTLY FOLLOWING CONNECTION TO EXISTING WATER SYSTEM (SEE STD. DWG. W-1).
- 12. ALL HYDRANTS TO BE OF THE SAME MANUFACTURER AS THE SELECTED VALVES.
- 13. THE CONTRACTOR SHALL BE RESPONSIBLE FOR ADEQUATE SIZING OF THRUST BLOCKS BASED ON FIELD CONDTIONS (SEE STD. DWG. W-4).
- 14. ALL 3-WAY FIRE HYDRANTS TO BE REMOVED SHALL BE SALVAGED AND RETURNED TO CITY OF HESPERIA PUBLIC WORK'S YARD.
- 15. CONTRACTOR TO CAP EXISTING WATER MAINS AS PER CITY OF HESPERIA INSPECTOR WHEN REQUIRED.
- 16. BACKFILL COMPACTION AND RESURFACING IN EXISTING STREETS SHALL CONFORM TO CITY STANDARDS OR LATEST REVISION THEREOF. A CERTIFICATION OF COMPACTION SIGNED BY A REGISTERED CIVIL ENGINEER SHALL BE SUBMITTED FOR ALL TRENCH BACKFILLS
- 17. ALL SERVICE CHANGEOVERS TO BE THE RESPONSIBILITY OF THE CONTRACTOR. EXISTING SERVICE LINES TO BE REMOVED AT THE TIME OF NEW CONNECTION FROM METER TO MAIN.

#### SEWER LINE INSTALLATION

- ALL MATERIALS AND INSTALLATION OF SEWER FACILITIES TO BE CONSTRUCTED SHALL BE IN ACCORDANCE WITH THESE PLANS, MANUFACTURER'S SPECIFICATIONS, CITY OF HESPERIA STANDARDS, AND MATERIAL LISTS.
- 2. IT IS THE CONTRACTOR'S RESPONSIBILITY TO MAINTAIN A CURRENT AND APPROVED SET OF CITY OF HESPERIA STANDARDS AND MATERIALS LIST ON THE JOB SITE AT ALL TIMES. CITY STANDARDS AND MATERIAL LISTS ARE AVAILABLE AT THE CITY OF HESPERIA ENGINEERING DEPARTMENT.
- 3. SEPARATION OF WATER AND SEWER FACILITIES SHALL CONFORM TO THE RULES AND REGULATIONS OF THE CITY OF HESPERIA STANDARDS (SEE STD. DWG. S-1).
- 4. ALL SEWER PIPE (UNLESS OTHERWISE NOTED) SHALL BE POLYVINYL CHLORIDE (PVC) S.D.R. 35.
- 5. SEWER PROFILE ELEVATIONS ARE TO THE INVERT OF THE PIPE.
- 6. SEWER LATERALS SHALL BE CONSTRUCTED IN ACCORDANCE WITH STANDARD LOCATIONS OF WYES AND LATERALS. WHERE NOT SHOWN ON THE PLANS LOCATION IS TO BE DETERMINED IN THE FIELD PRIOR TO CONSTRUCTION. CLEANOUT LOCATIONS SHALL NOT BE INSTALLED IN DRIVEWAY WHERE APPLICABLE. ALL LATERALS ARE TO BE 6" DIAMETER UNLESS OTHERWISE NOTED ON THE PLANS.
- 7. PRIOR TO CONSTRUCTION OF SEWER, CONTRACTOR SHALL EXPOSE EXISTING SEWER AND VERIFY ITS EXISTING ELEVATION AND LOCATION BEFORE CONNECTING TO EXISTING MANHOLE OR STUB. CONTRACTOR IS RESPONSIBLE TO NOTIFY THE CITY ENGINEER IF ELEVATIONS ARE NOT PER PLAN AND REQUIRE ADJUSTMENTS IN THE FIFLD
- 8. IT SHALL BE THE SEWER CONTRACTOR'S RESPONSIBILITY TO SET CLEAN-OUTS TO FINISH GRADE.
- 9. SEWER PIPE ZONE AND TRENCH BACKFILL SHALL BE PLACED IN ACCORDANCE WITH THE CITY OF HESPERIA STANDARDS. (SEE STD. DWG. S-1).
- 10. MANHOLES SHALL BE ADJUSTED TO GRADE AFTER PLACING SURFACE COURSE ASPHALT CONCRETE.
- 11. MANHOLE COVERS TO BE LOCK-DOWN TYPE. (SEE STD. DWG. S-8).
- 12. SEWER LATERALS SHALL BE CONNECTED TO THE MAIN WITH GASKETED WYES.
- 13. SEWER LINES SHALL BE TESTED PRIOR TO MAKING PERMANENT SERVICE CONNECTION. SEWER TESTING SHALL INCLUDE BALL AND MANDREL, PRESSURE TEST AND VIDEO BEFORE PERMANENT PAVING IS COMPLETED. ALL TRACTS WILL BE REQUIRED TO VIDEO AGAIN PRIOR TO THE RELEASE OF BONDS.

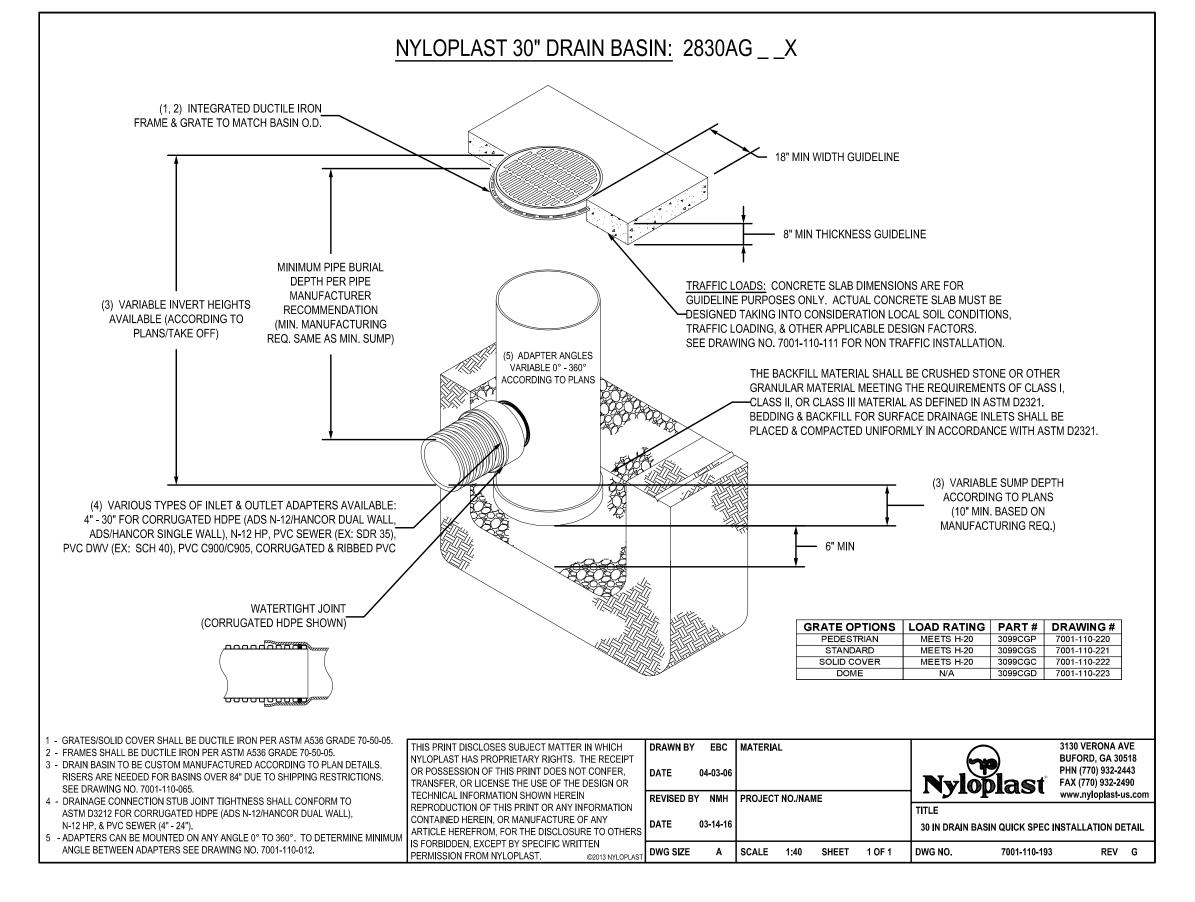



# BENCHMARK: "H-18" BRASS DISK IN CONCRETE, LOCATED APPROXIMATELY 22 FEET NORTH OF THE NE ECR, BEHIND THE SIDEWALK AT THE INTERSECTION OF MAIN ST. & MAPLE ST. ELEV=3376.492 DESIGNED BY: D.B.W. DRAWN BY: D.B.W. CHECKED BY: R.J.A. SUBMITTED BY: RAYMOND J. ALLARD RCE No. 36052 DATE



## HIGH DESERT MAPPING

Land Surveying - Civil Design 16704 Neenach Road Apple Valley, CA 92307 (760) 508-8555

dbw.hdm@gmail.com

ENGINEERING	DEF	PARTI	MENT	
RECOMMENDED FOR APPROVAL BY:		А	PPROVED BY:	
DATE	CAS	SANDRA SA	ANCHEZ	DATE
	RCF	74776	EXD DATE	12/31/25

**CITY ENGINEER** 


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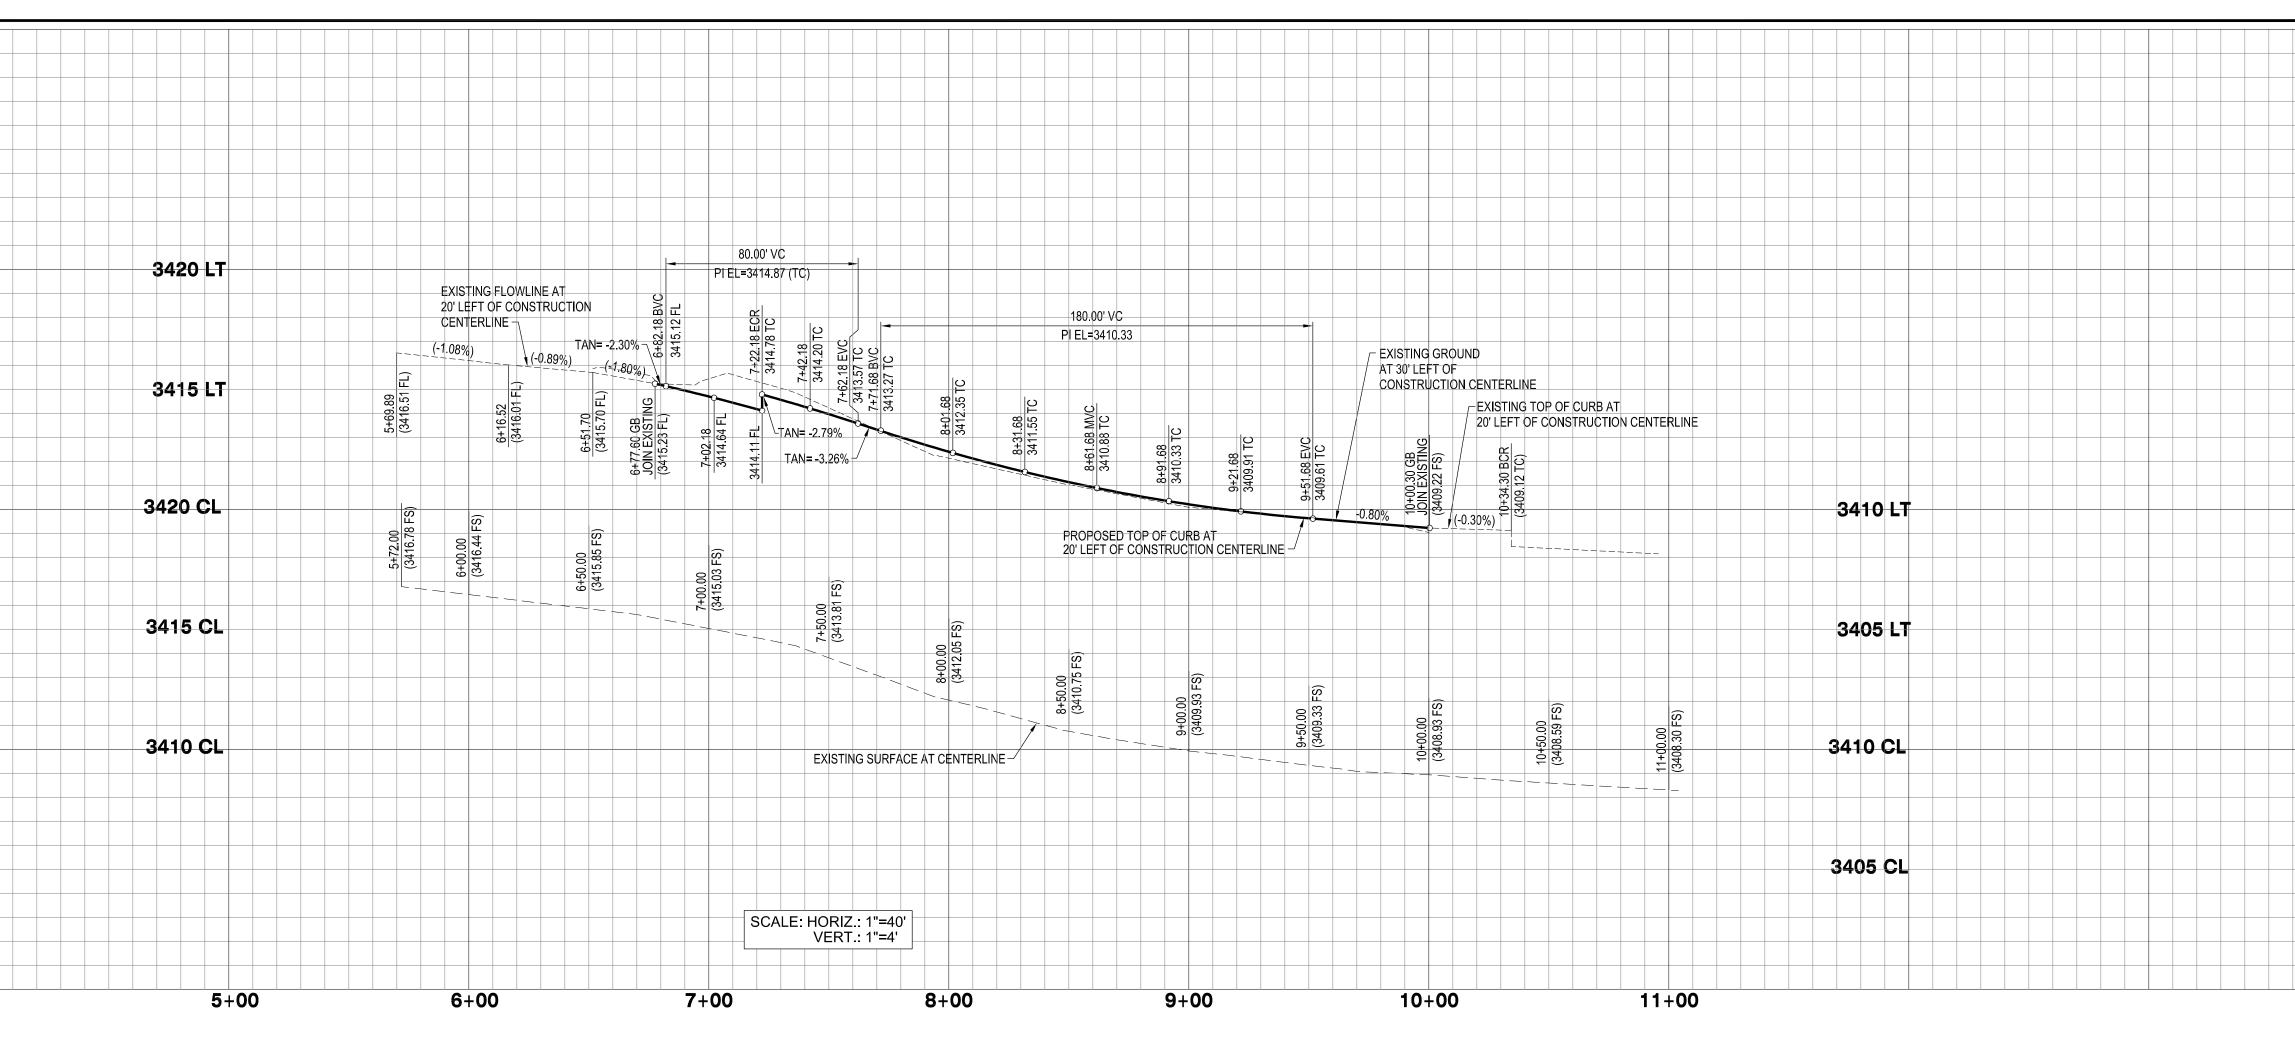
**CITY OF HESPERIA** 


CITY OF HESPERIA
<b>NOTES &amp; DETAILS</b>
TAMARISK APARTMENTS
MUNEM MAIDA

APN 3057-121-08

SHEET	
2	
$\mathbf{OF}$	
13	
N-1	



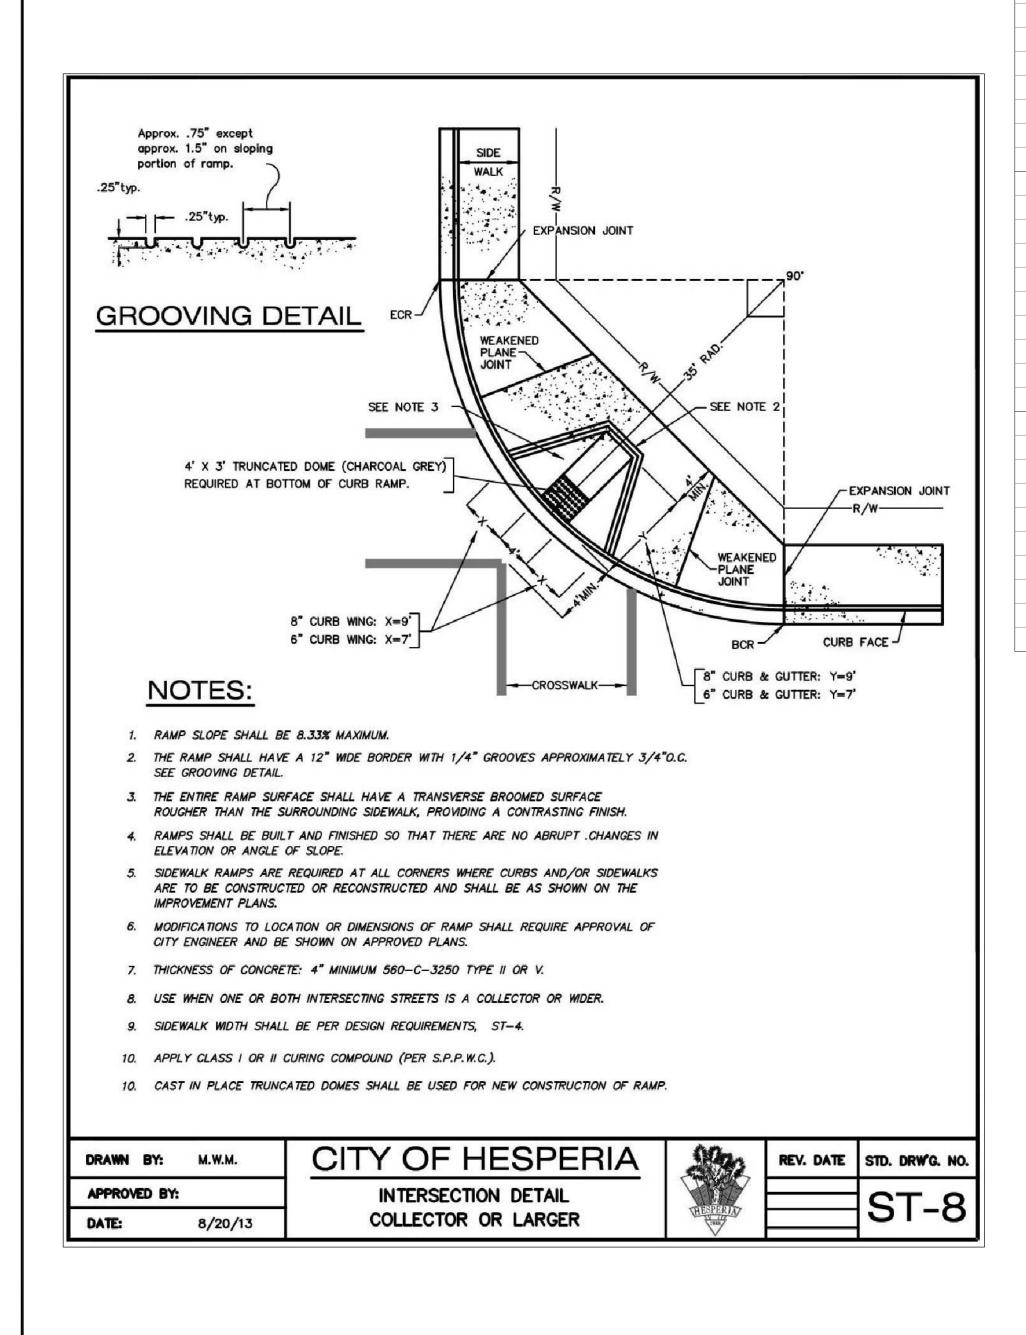

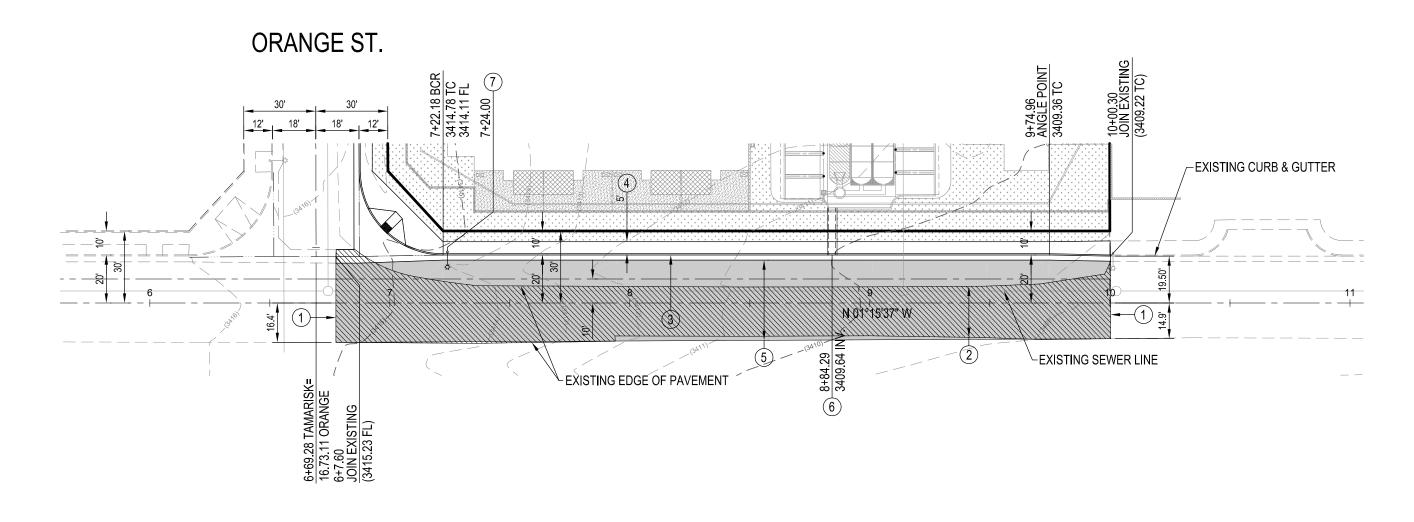



SCALE: 1"=40'

TAMARISK AVENUE

**AUTHORIZED SIGNATURE** 

## CONSTRUCTION NOTES:

CONS	STRUCTION NOTES:	
1	SAWCUT EXISTING PAVEMENT TO A CLEAN STRAIGHT LINE, FEATHER EDGE OVER FOR A SMOOTH TRANSITION 2' MIN.	78 L.F.
2	REMOVE EXISTING IMPROVEMENTS TO THE LIMITS SHOWN	7,550 S.F
3	CONSTRUCT 8" CURB AND GUTTER PER SPPWC 120-2 (A2-8)	278 L.F.
4	CONSTRUCT SIDEWALK PER CITY STD. ST-4, TYPE A	1,390 S.F
5	CONSTRUCT 6.5" AC PAVEMENT OVER 9" CLASS II BASE	10,755 S
6	CONSTRUCT PARKWAY DRAIN PER APWA STD. 151-2, W=3'0"	1 EA.
7	INSTALL STREET LIGHT PER CITY STD. ST-10	2 EA.

Know what's below.
Call before you dig.

			BENCHMARK:
			"H-18"
			BRASS DISK IN CONCRETE, LOCATED AI
			22 FEET NORTH OF THE NE ECR, BEHIN
			SIDEWALK AT THE INTERSECTION OF M ST.
			· · · · · · · · · · · · · · · · · · ·
REV.	DESCRIPTION DATE	BY	ELEV=3376.492

DESIGNED BY: D.B.W.

DRAWN BY: D.B.W.

OAPPROXIMATELY
IND THE

MAIN ST. & MAPLE

SUBMITTED BY:

SUBMITTED BY:

RAYMOND J. ALLARD RCE No. 36052



DATE

## HIGH DESERT MAPPING

Land Surveying - Civil Design

16704 Neenach Road
Apple Valley, CA 92307
(760) 508-8555

dbw.hdm@gmail.com

	HESPERIA DEPARTMENT
RECOMMENDED FOR APPROVAL BY:	APPROVED BY:

CASSANDRA SANCHEZ

R.C.E. 74776 EXP. DATE 12/31/25 CITY ENGINEER


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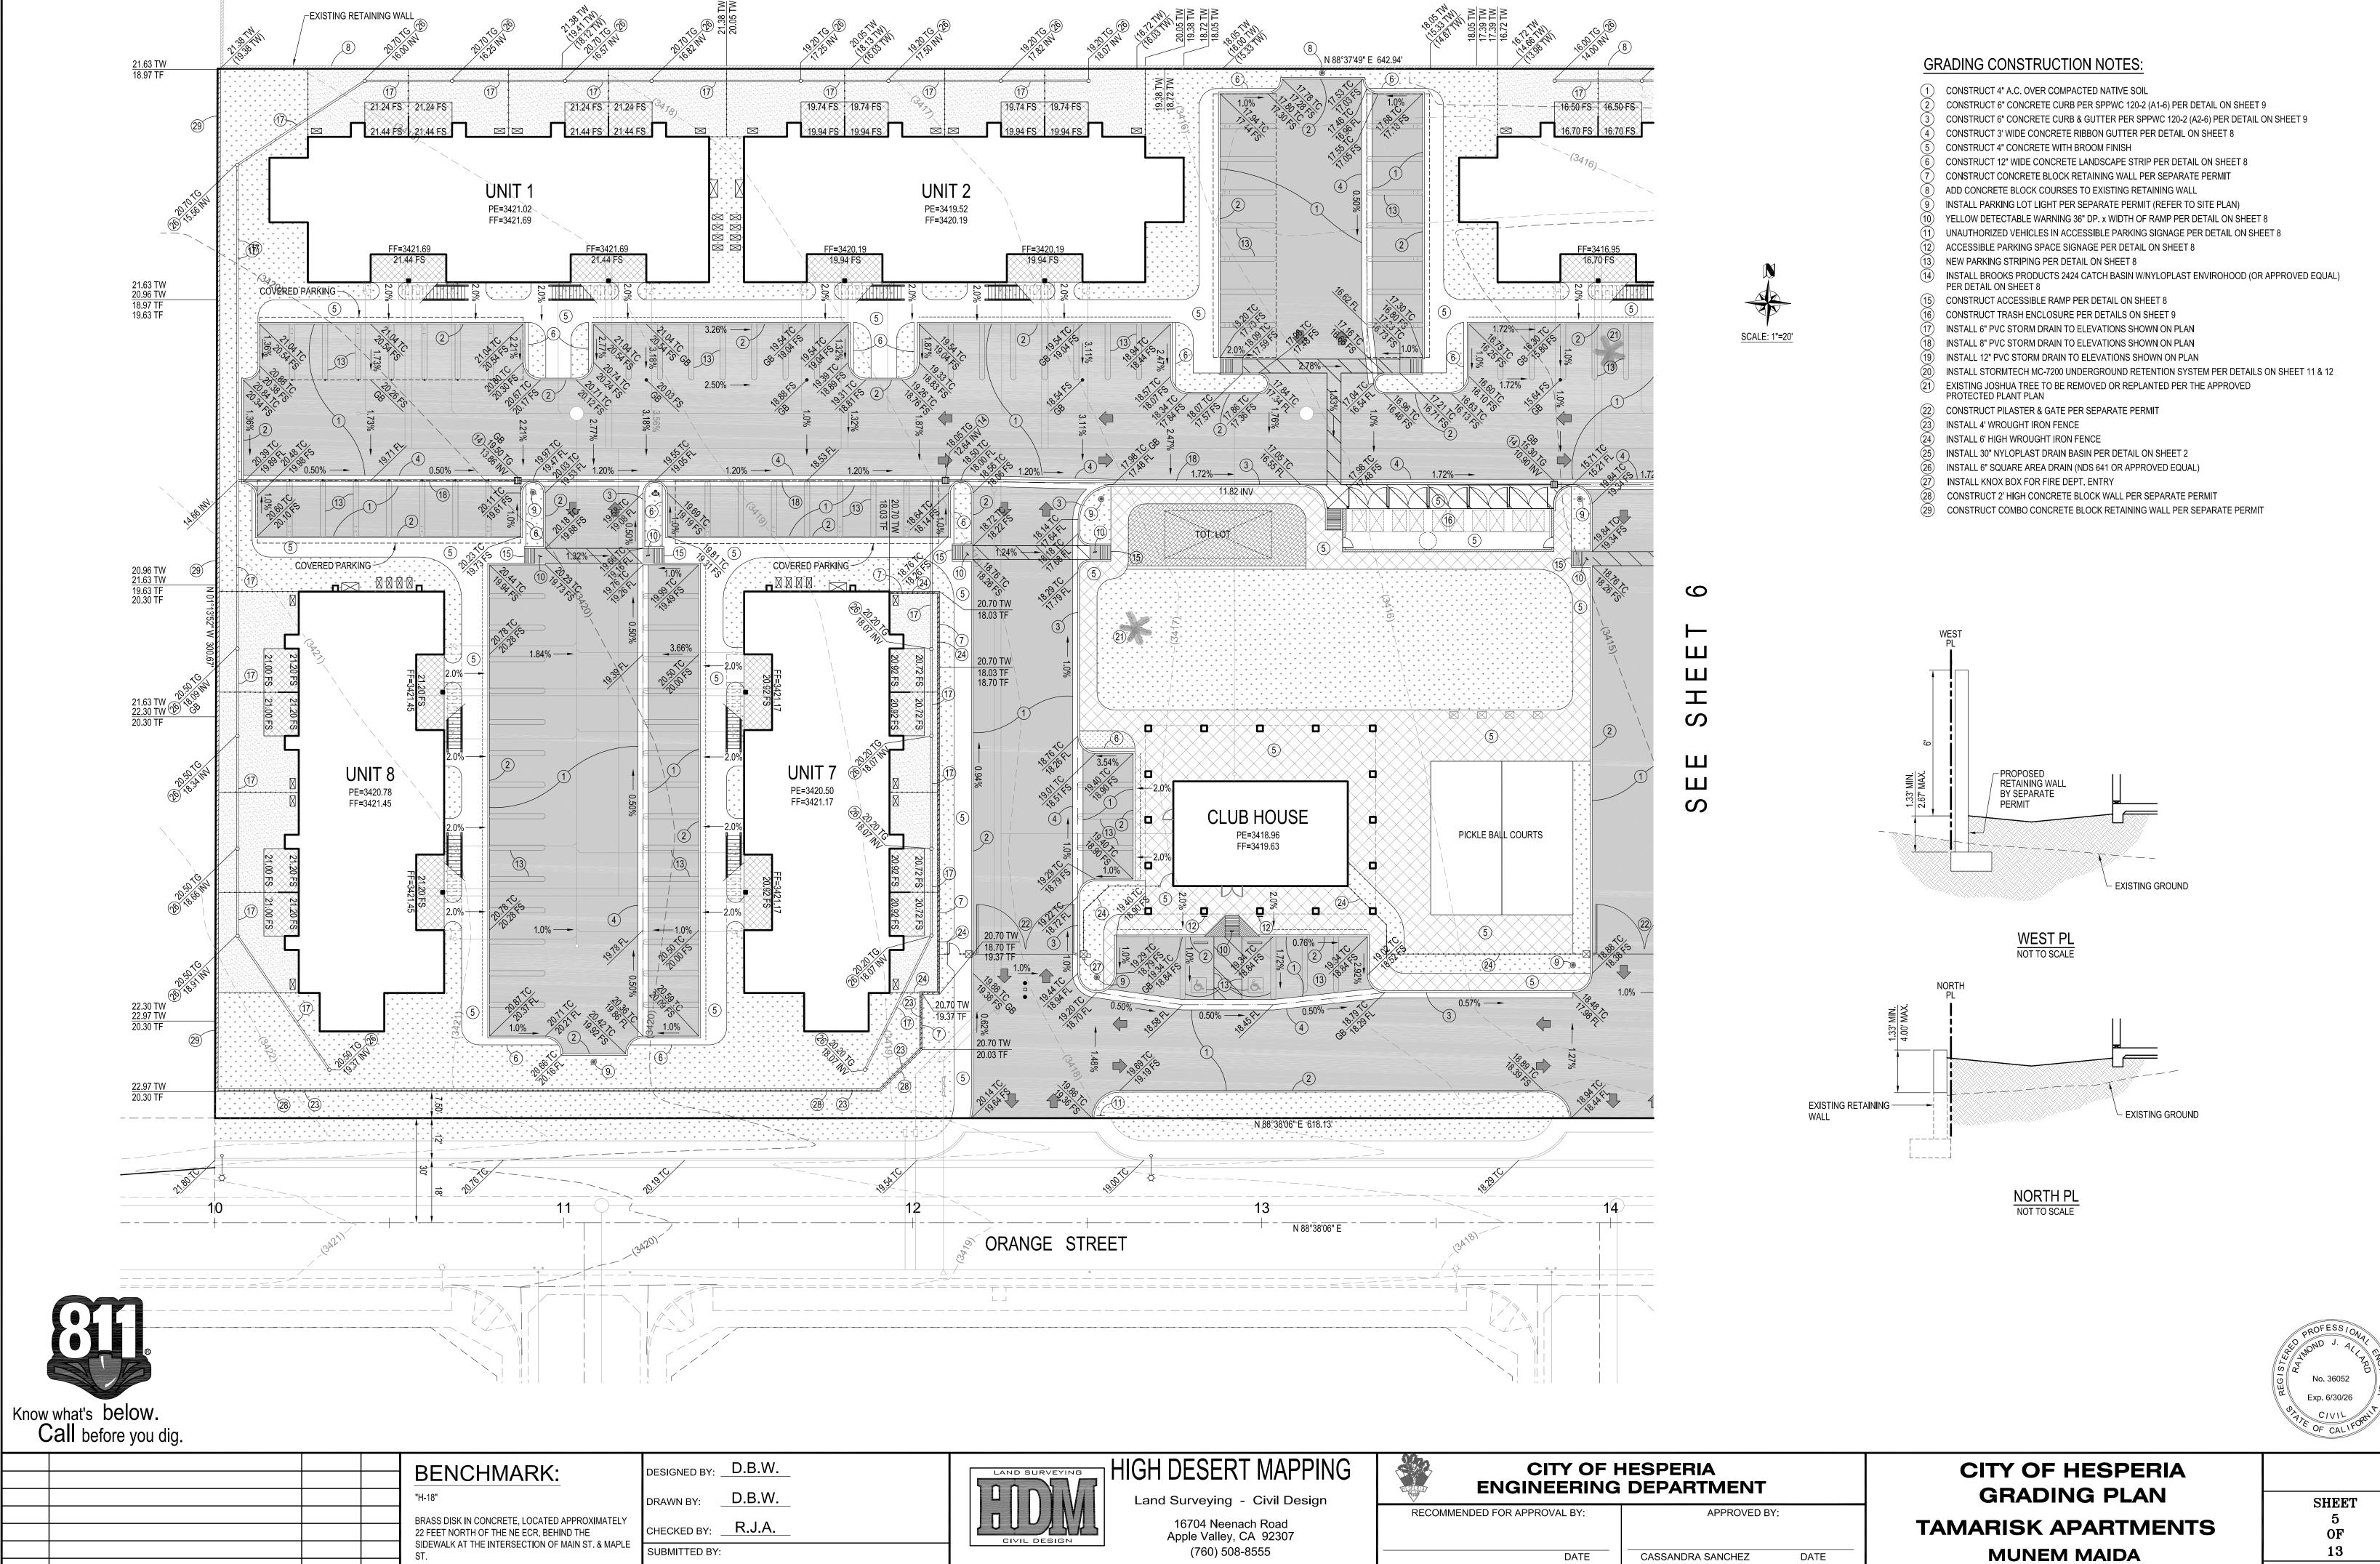
CITY OF HESPERIA
STREET IMPROVEMENT PLAN
TAMARISK APARTMENTS
MUNEM MAIDA

APN 3057-121-08

SHEET
3
OF
13
ST-1

No. 36052 Exp. 6/30/26



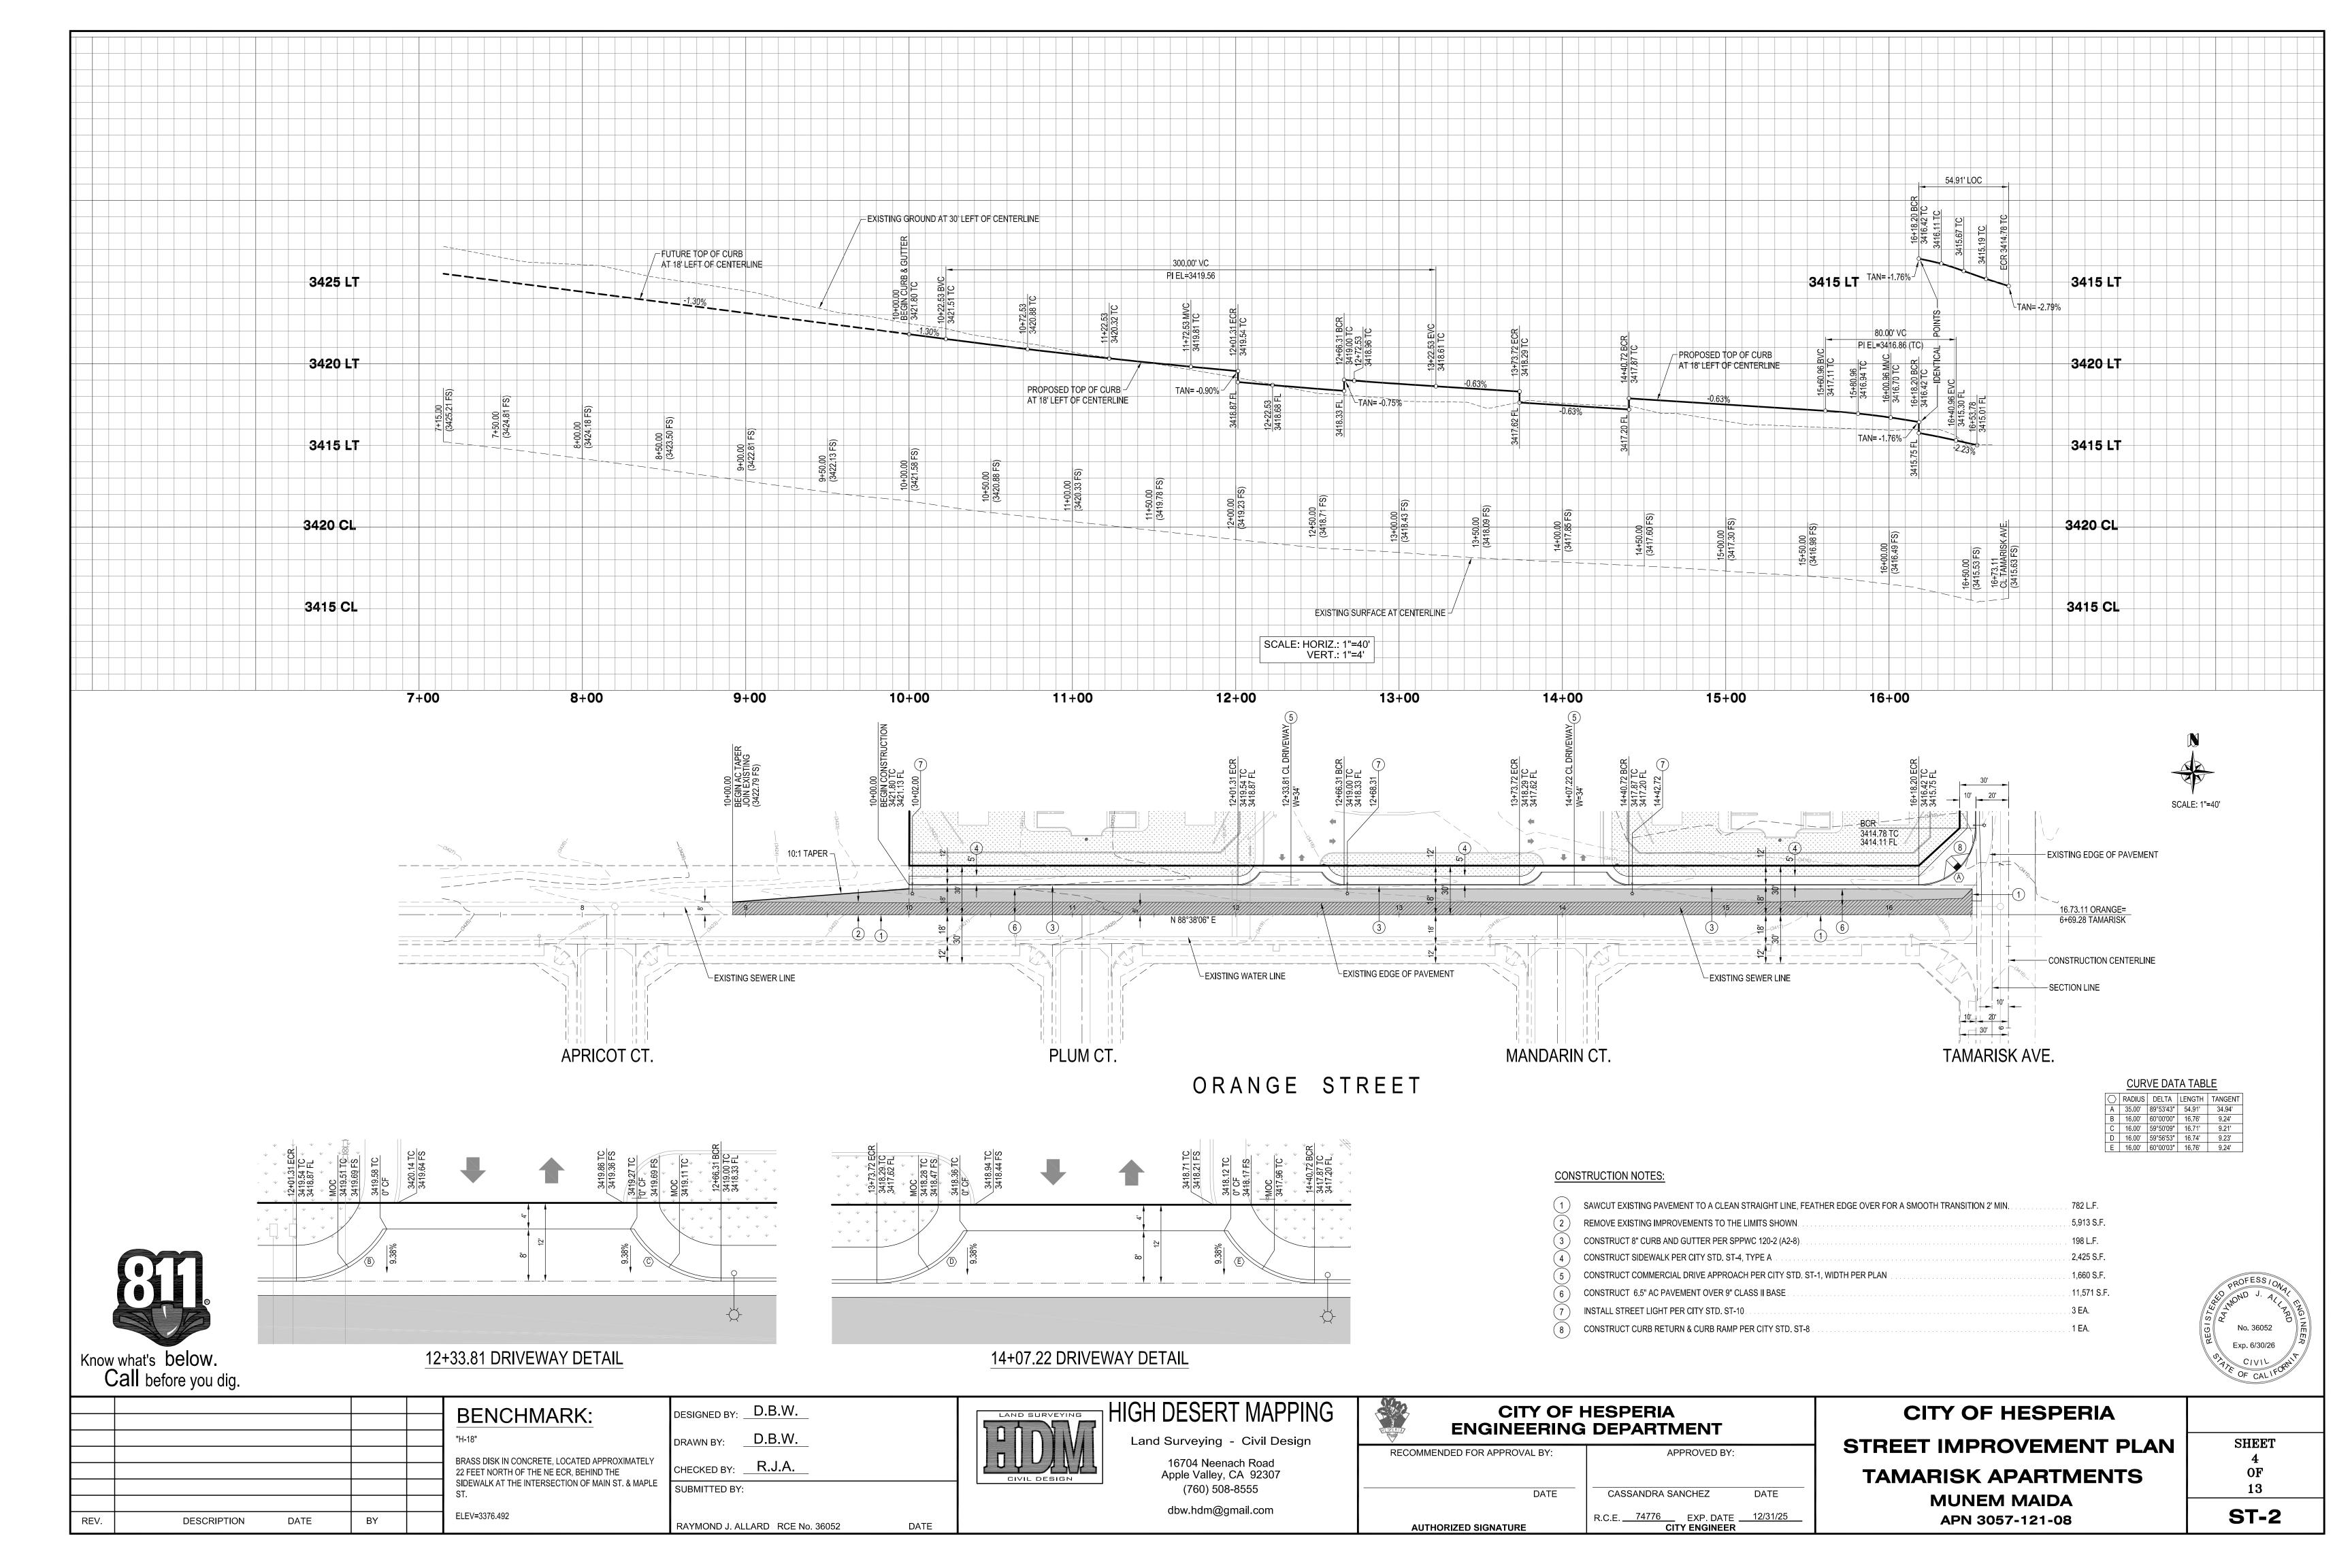

dbw.hdm@gmail.com

ELEV=3376.492

RAYMOND J. ALLARD RCE No. 36052

DESCRIPTION


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APN 3057-121-08


R.C.E. 74776 EXP. DATE 12/31/25 CITY ENGINEER


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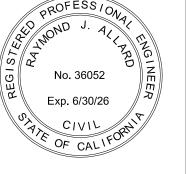
## GRADING CONSTRUCTION NOTES:

- CONSTRUCT 4" A.C. OVER COMPACTED NATIVE SOIL
- CONSTRUCT 6" CONCRETE CURB PER SPPWC 120-2 (A1-6) PER DETAIL ON SHEET 9
- CONSTRUCT 6" CONCRETE CURB & GUTTER PER SPPWC 120-2 (A2-6) PER DETAIL ON SHEET 9
- CONSTRUCT 3' WIDE CONCRETE RIBBON GUTTER PER DETAIL ON SHEET 8
- CONSTRUCT 4" CONCRETE WITH BROOM FINISH CONSTRUCT 12" WIDE CONCRETE LANDSCAPE STRIP PER DETAIL ON SHEET 8
- CONSTRUCT CONCRETE BLOCK RETAINING WALL PER SEPARATE PERMIT
- ADD CONCRETE BLOCK COURSES TO EXISTING RETAINING WALL
- INSTALL PARKING LOT LIGHT PER SEPARATE PERMIT (REFER TO SITE PLAN) YELLOW DETECTABLE WARNING 36" DP. x WIDTH OF RAMP PER DETAIL ON SHEET 8
- UNAUTHORIZED VEHICLES IN ACCESSIBLE PARKING SIGNAGE PER DETAIL ON SHEET 8
- ACCESSIBLE PARKING SPACE SIGNAGE PER DETAIL ON SHEET 8
- NEW PARKING STRIPING PER DETAIL ON SHEET 8
- INSTALL BROOKS PRODUCTS 2424 CATCH BASIN W/NYLOPLAST ENVIROHOOD (OR APPROVED EQUAL) PER DETAIL ON SHEET 8
- CONSTRUCT ACCESSIBLE RAMP PER DETAIL ON SHEET 8
- CONSTRUCT TRASH ENCLOSURE PER DETAILS ON SHEET 9
- INSTALL 6" PVC STORM DRAIN TO ELEVATIONS SHOWN ON PLAN
- INSTALL 8" PVC STORM DRAIN TO ELEVATIONS SHOWN ON PLAN
- INSTALL 12" PVC STORM DRAIN TO ELEVATIONS SHOWN ON PLAN INSTALL STORMTECH MC-7200 UNDERGROUND RETENTION SYSTEM PER DETAILS ON SHEET 11 & 12
- EXISTING JOSHUA TREE TO BE REMOVED OR REPLANTED PER THE APPROVED PROTECTED PLANT PLAN
- CONSTRUCT PILASTER & GATE PER SEPARATE PERMIT
- INSTALL 4' WROUGHT IRON FENCE
- INSTALL 6' HIGH WROUGHT IRON FENCE
- INSTALL 30" NYLOPLAST DRAIN BASIN PER DETAIL ON SHEET 2
- INSTALL 6" SQUARE AREA DRAIN (NDS 641 OR APPROVED EQUAL)
- INSTALL KNOX BOX FOR FIRE DEPT. ENTRY CONSTRUCT 2' HIGH CONCRETE BLOCK WALL PER SEPARATE PERMIT
- CONSTRUCT COMBO CONCRETE BLOCK RETAINING WALL PER SEPARATE PERMIT



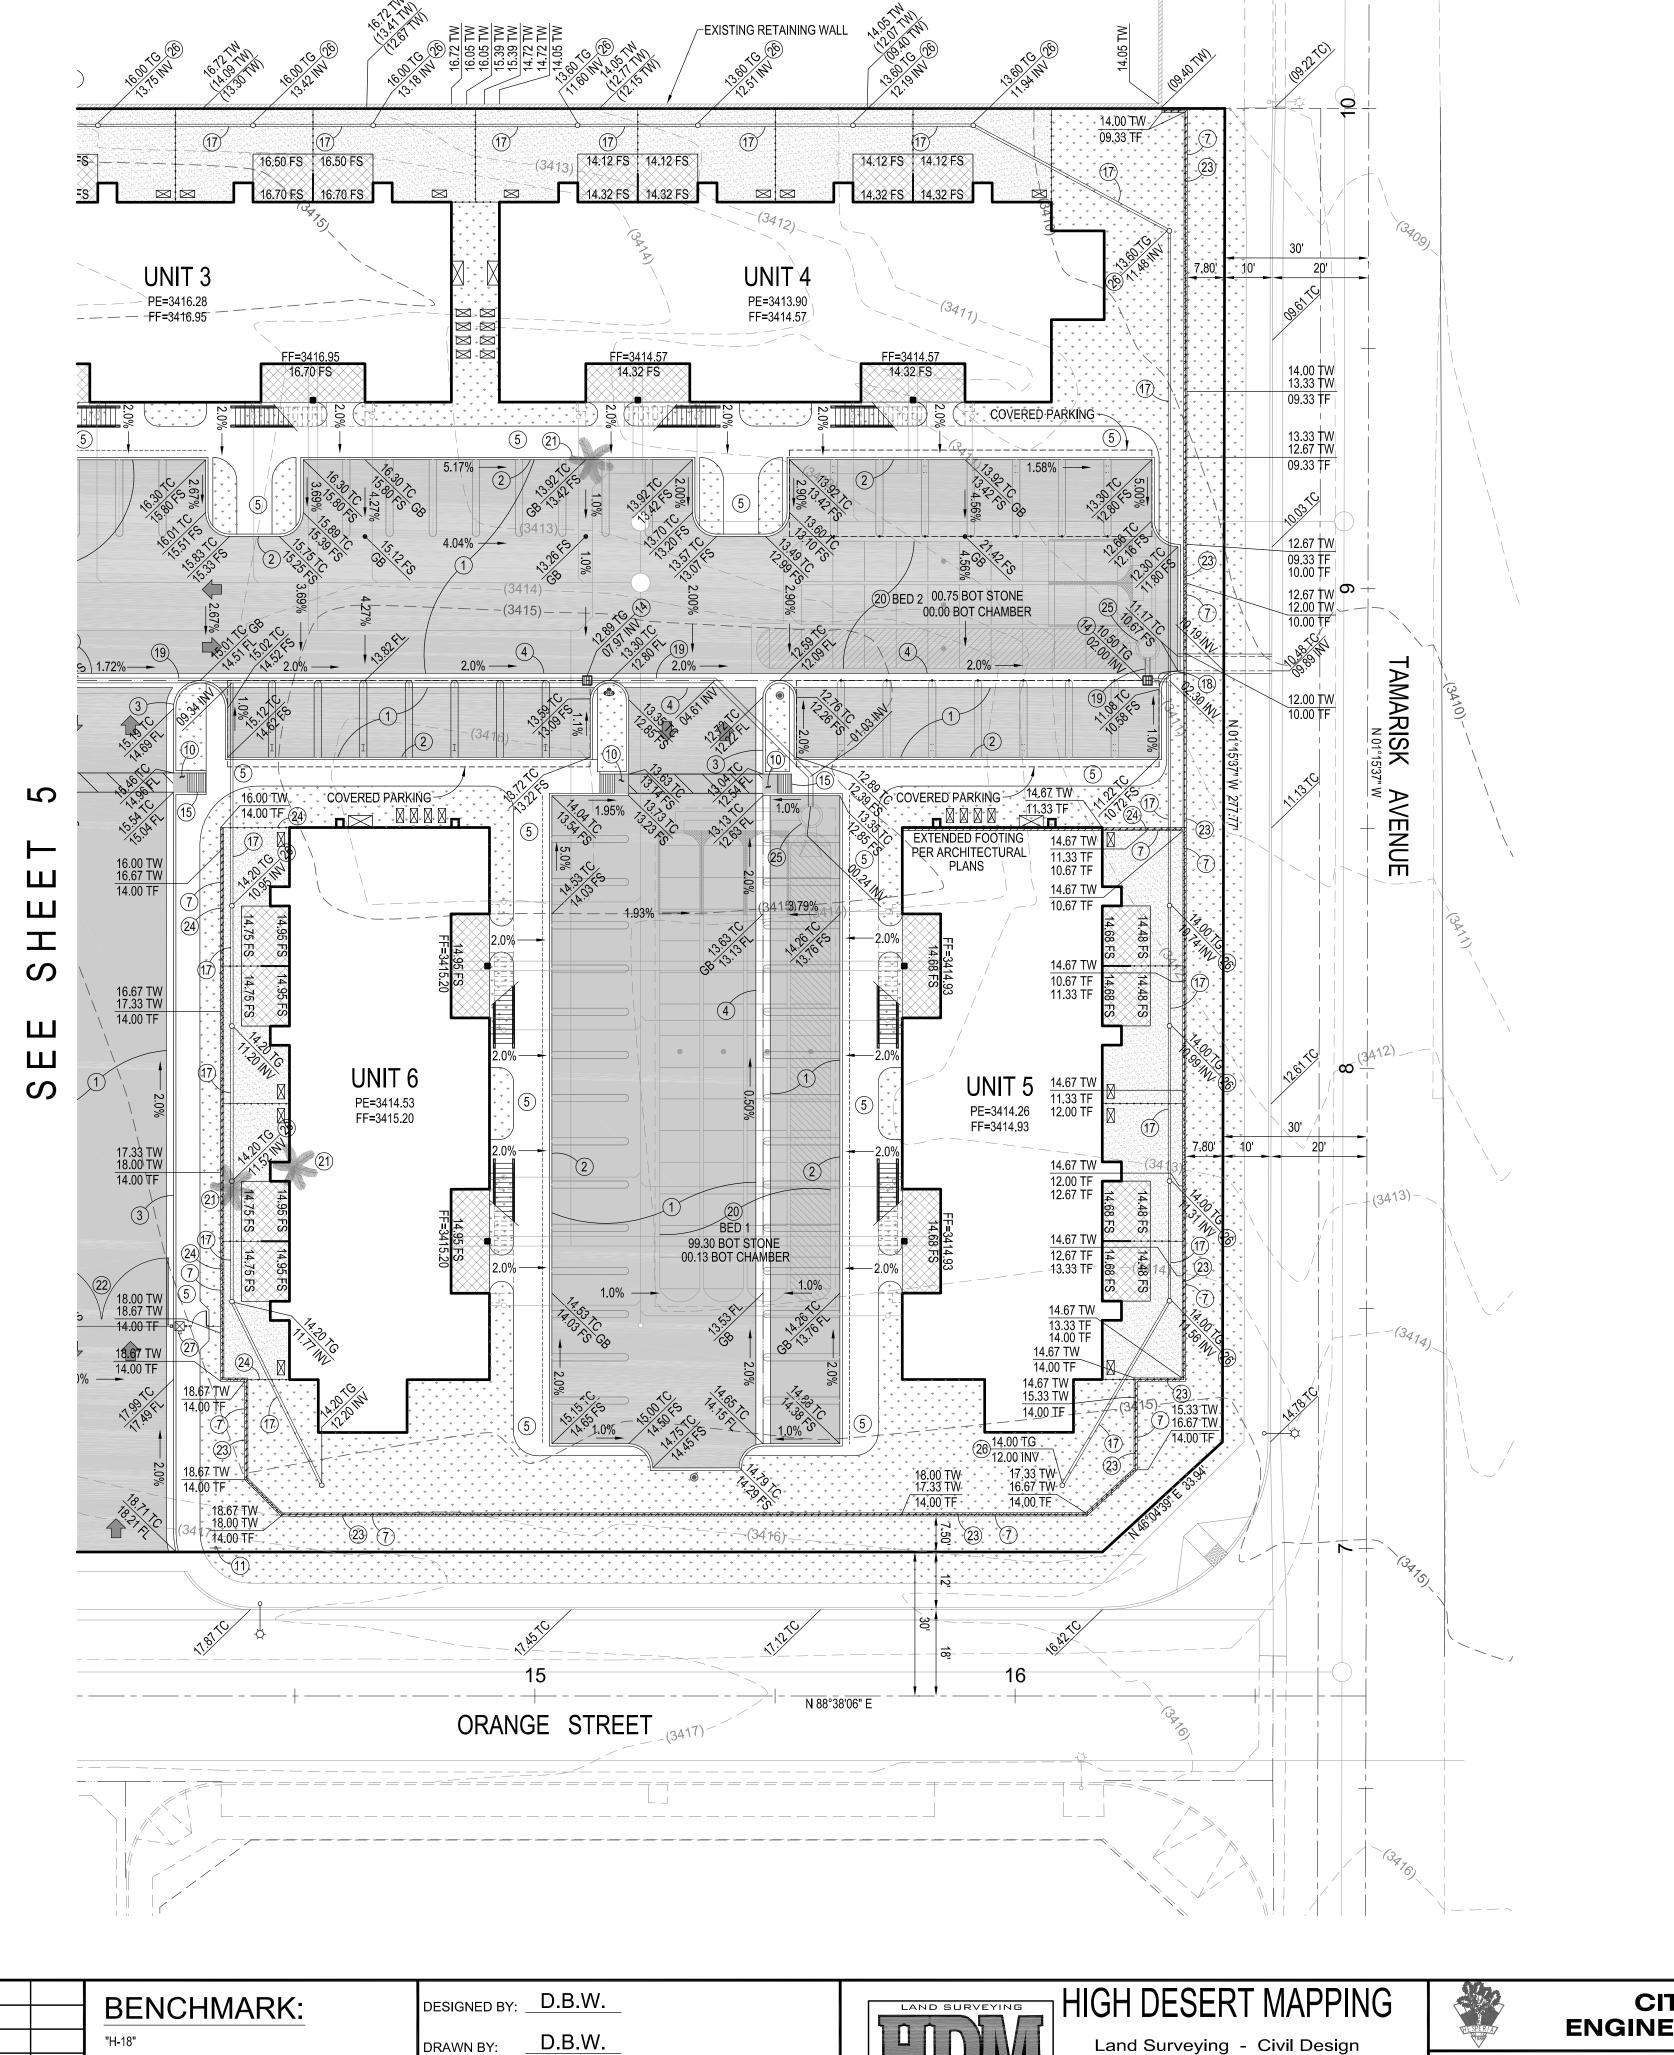

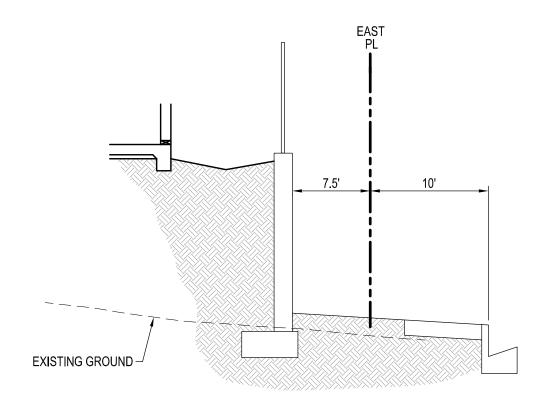

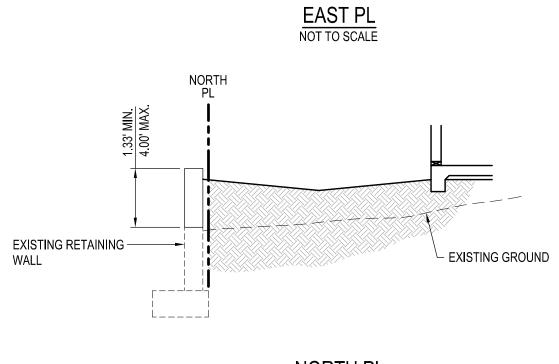

Know what's below. Call before you dig.							
		_					

DESCRIPTION

DATE

ELEV=3376.492

DRAWN BY: BRASS DISK IN CONCRETE, LOCATED APPROXIMATELY CHECKED BY: R.J.A. 22 FEET NORTH OF THE NE ECR, BEHIND THE SIDEWALK AT THE INTERSECTION OF MAIN ST. & MAPLE SUBMITTED BY:

RAYMOND J. ALLARD RCE No. 36052

DATE

Land Surveying - Civil Design 16704 Neenach Road Apple Valley, CA 92307 (760) 508-8555 dbw.hdm@gmail.com


CITY OF HESPERIA ENGINEERING DEPARTMENT						
RECOMMENDED FOR APPROVAL BY:	APPROVED BY:					
DATE	CASSANDRA SANCHEZ DATE	<u> </u>				

**AUTHORIZED SIGNATURE** 

R.C.E. 74776 EXP. DATE 12/31/25 CITY ENGINEER

SCALE: 1"=20'

APN 3057-121-08

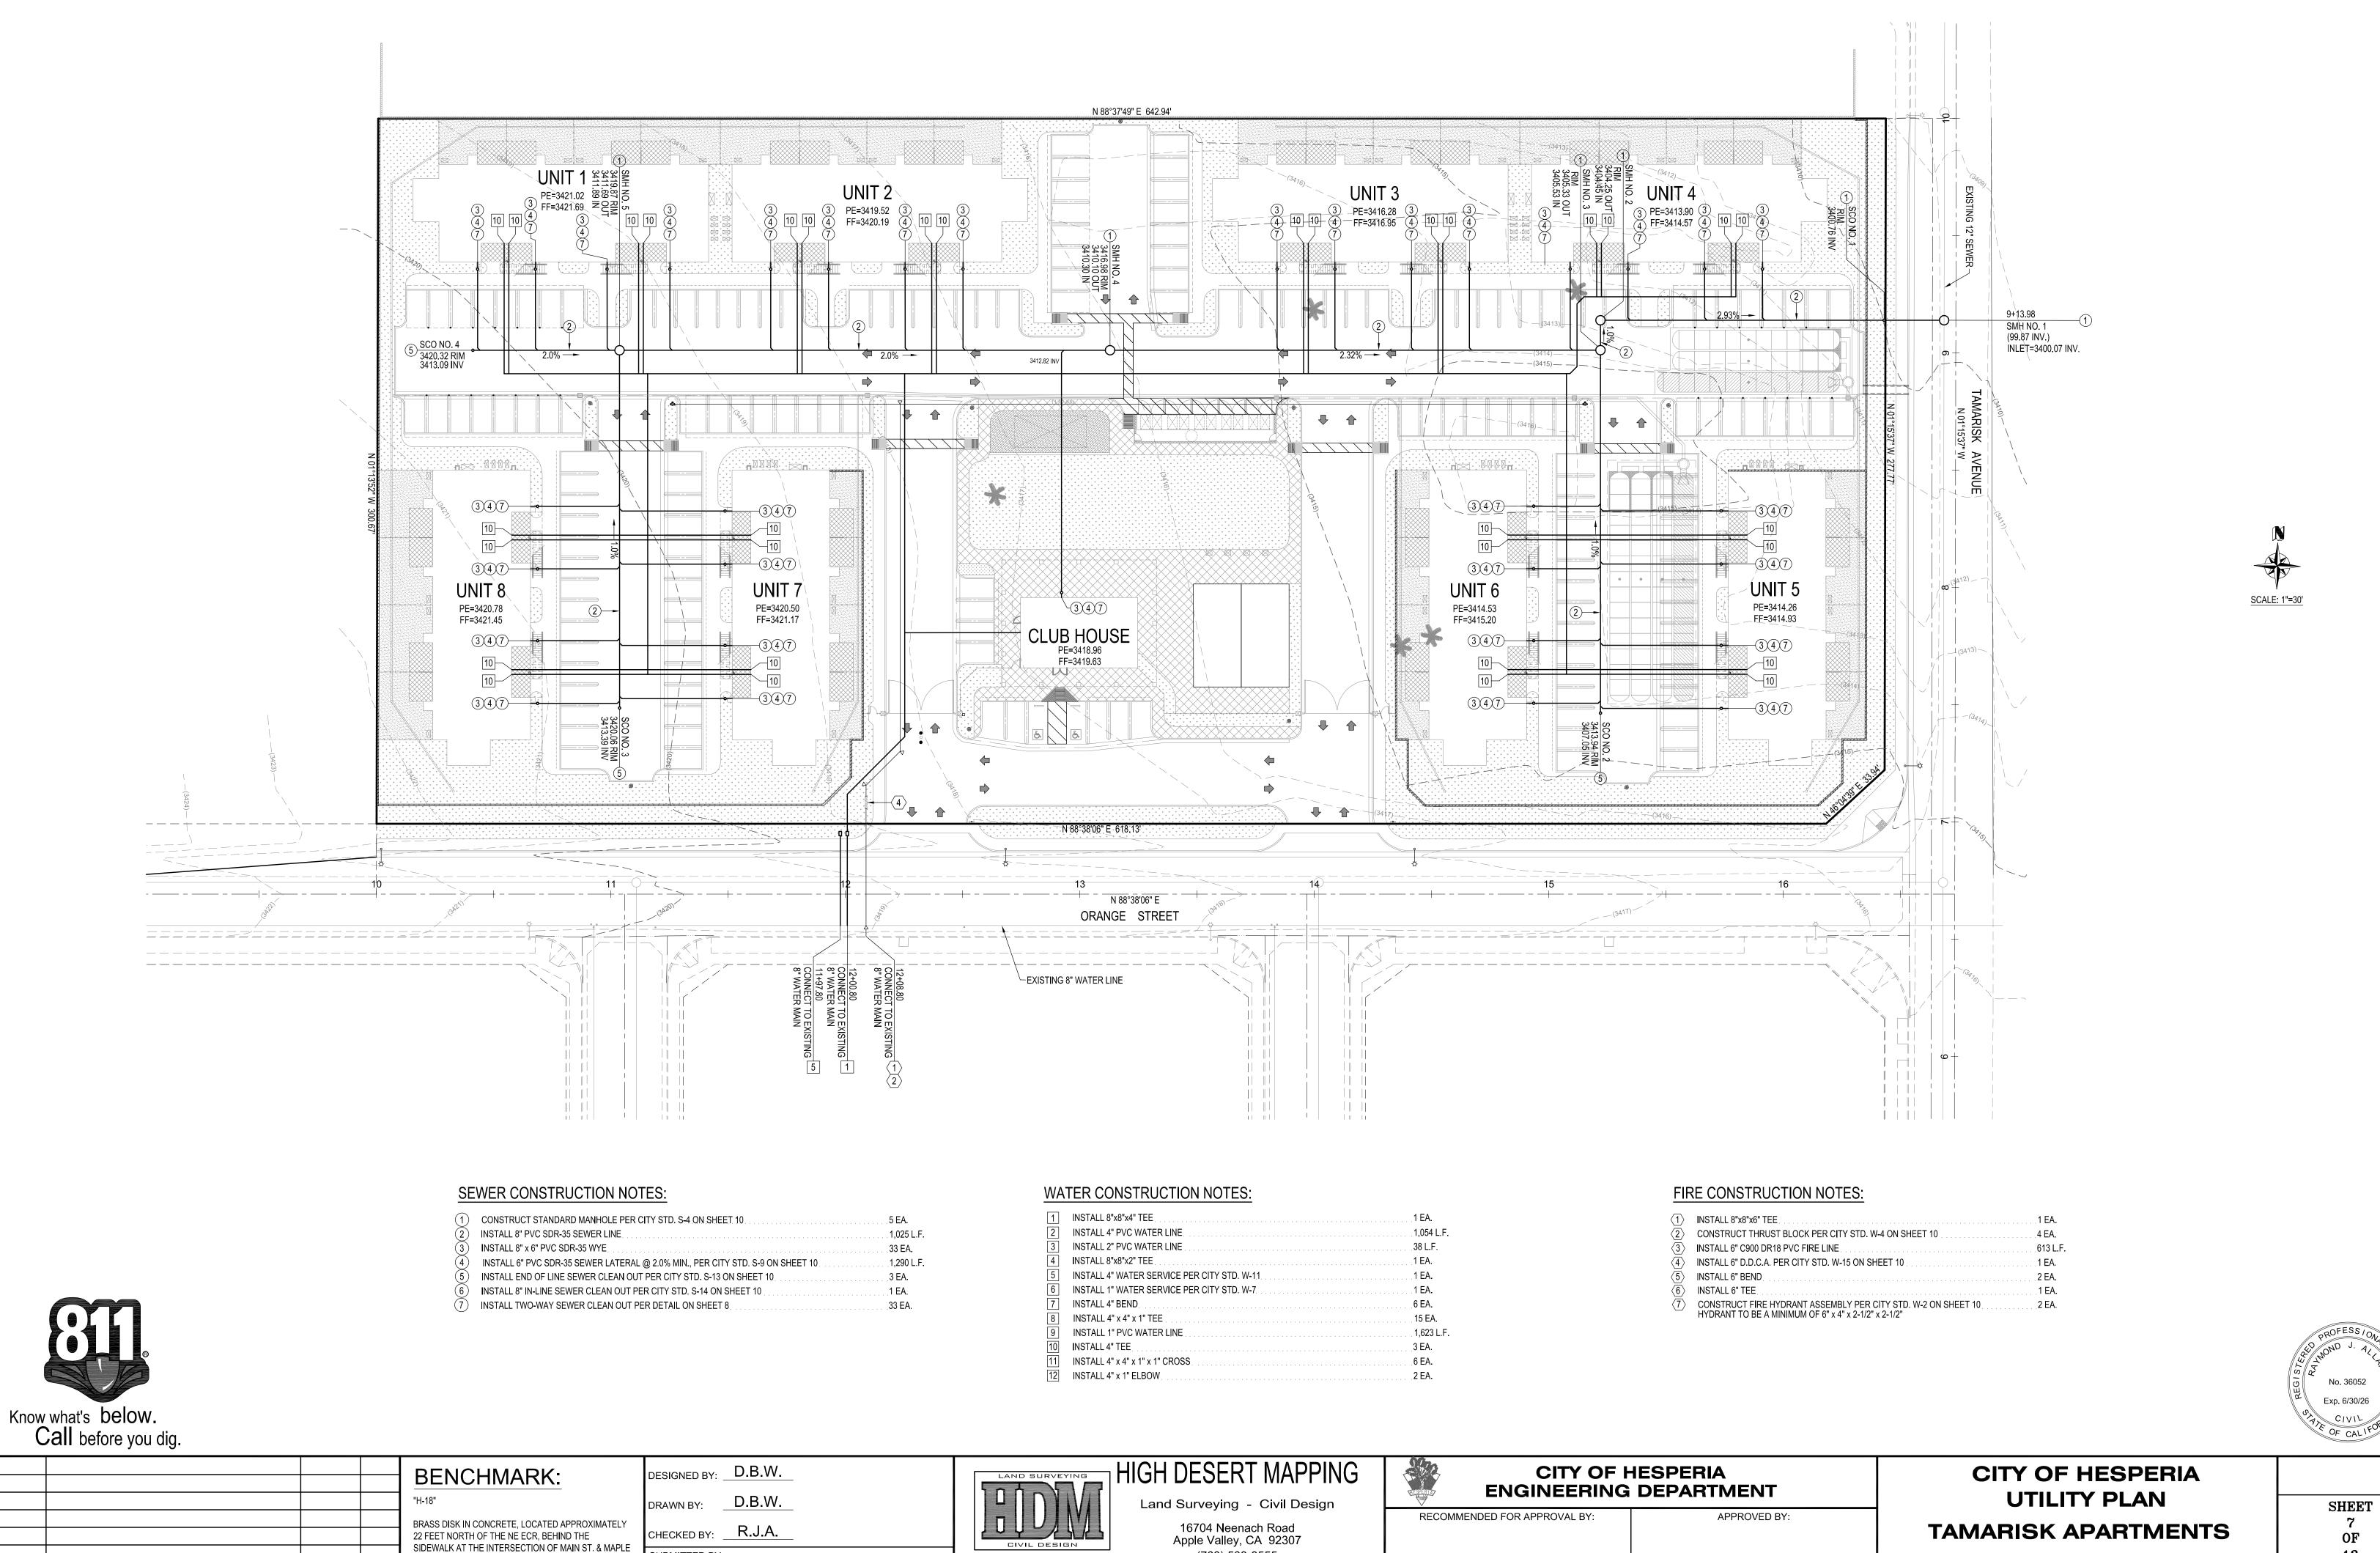

(760) 508-8555

dbw.hdm@gmail.com

DATE

**AUTHORIZED SIGNATURE** 

CASSANDRA SANCHEZ

R.C.E. 74776 EXP. DATE 12/31/25 CITY ENGINEER

DATE

SUBMITTED BY:

RAYMOND J. ALLARD RCE No. 36052


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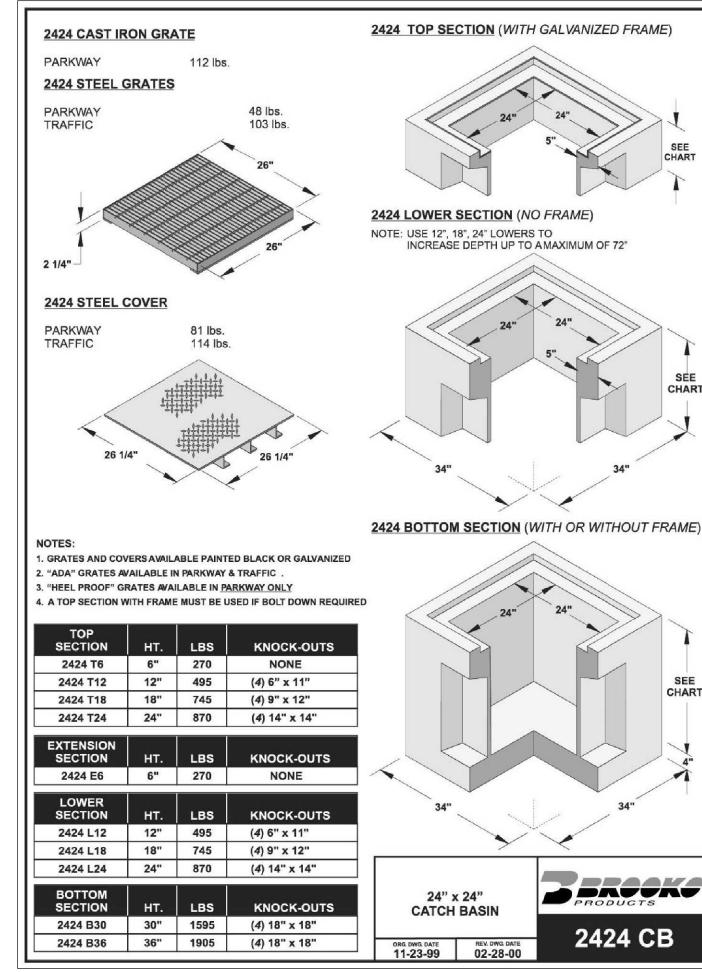
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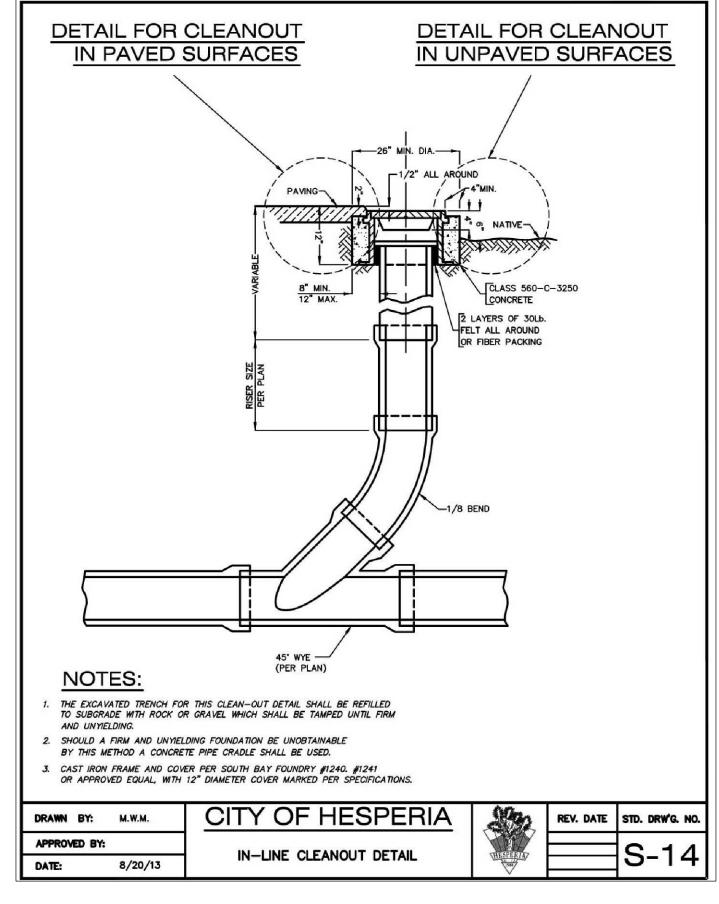
OF 13 **U-1** 

**MUNEM MAIDA** 

APN 3057-121-08







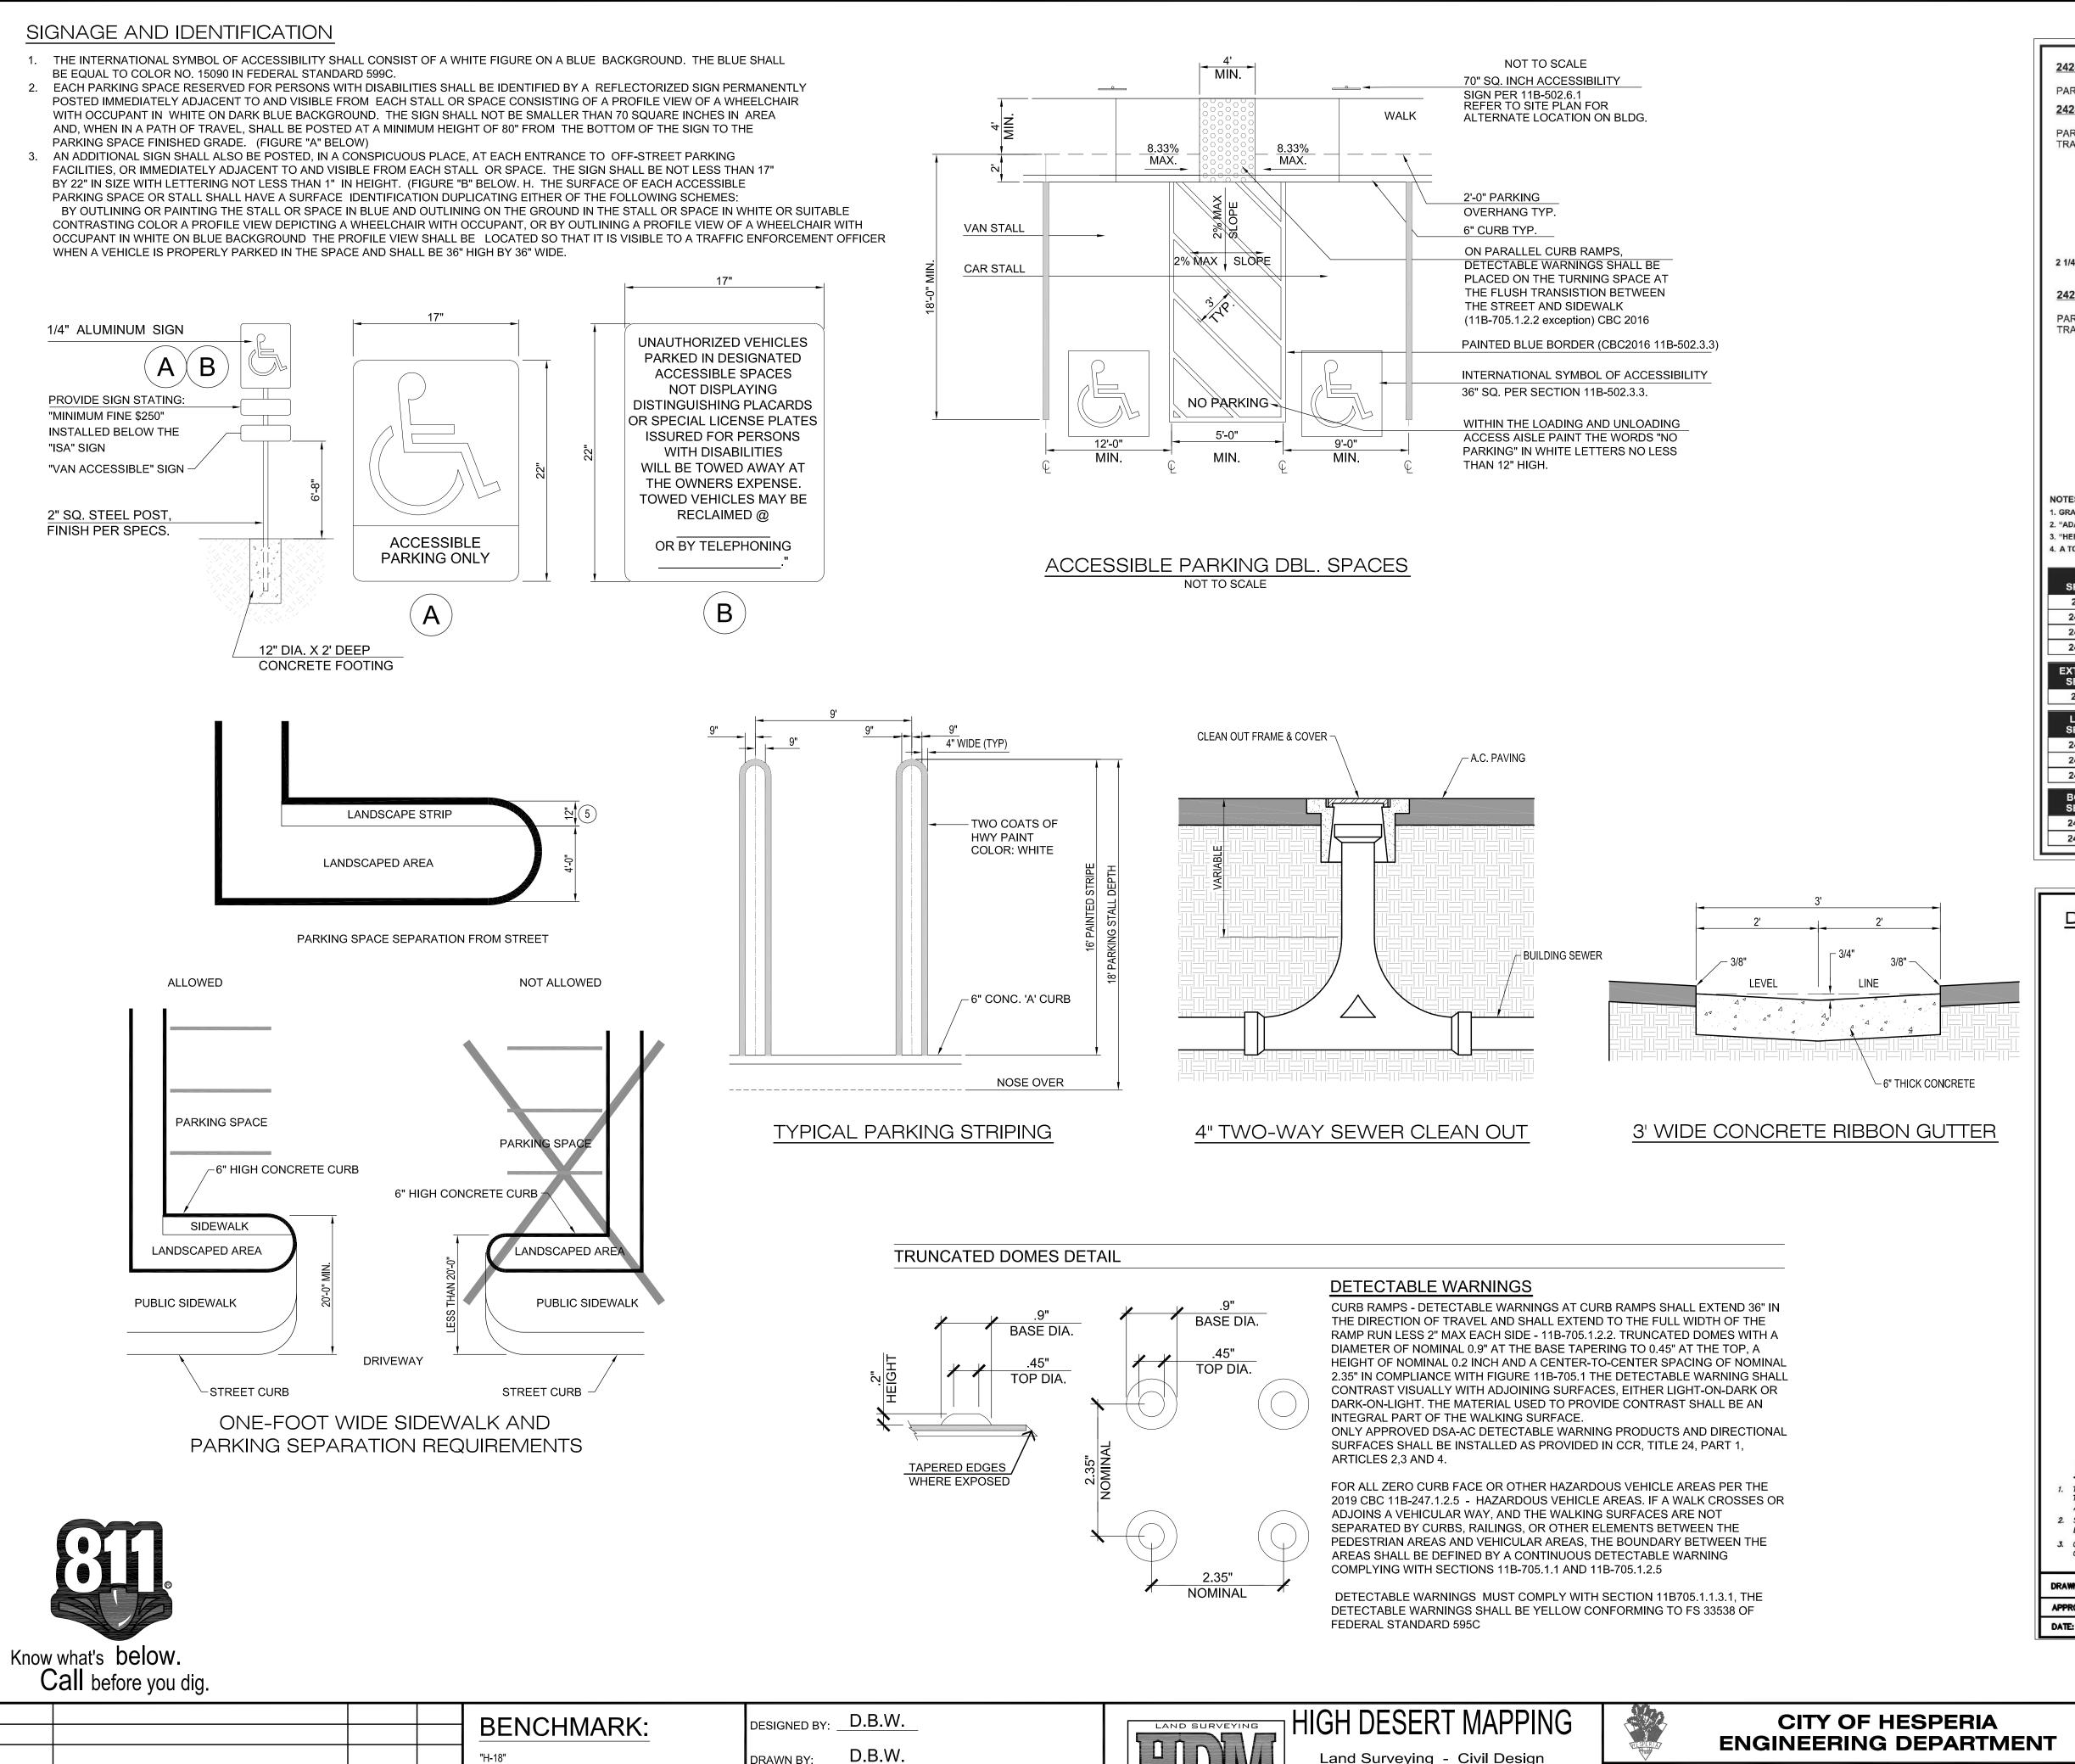






Call before you dig.										OF CALIFE
		BENCHMARK:	DESIGNED BY: D.B.W.		LAND SURVEYING	HIGH DESERT MAPPING		HESPERIA DEPARTMENT	CITY OF HESPERIA	
		"H-18"	DRAWN BY: D.B.W.			Land Surveying - Civil Design	RECOMMENDED FOR APPROVAL BY:	APPROVED BY:	DETAILS	SHEET
		BRASS DISK IN CONCRETE, LOCATED APPROXIMATELY 22 FEET NORTH OF THE NE ECR, BEHIND THE	CHECKED BY: R.J.A.		GIVIL DESIGN	16704 Neenach Road Apple Valley, CA 92307		,	TAMARISK APARTMENTS	OF
		SIDEWALK AT THE INTERSECTION OF MAIN ST. & MAPLE ST.	SUBMITTED BY:			(760) 508-8555	DATE	CASSANDRA SANCHEZ DATE	MUNEM MAIDA	13
REV. DESCRIPTION DATE	BY	ELEV=3376.492	RAYMOND J. ALLARD RCE No. 36052	DATE		dbw.hdm@gmail.com	AUTHORIZED SIGNATURE	R.C.E. <u>74776</u> EXP. DATE <u>12/31/25</u> CITY ENGINEER	APN 3057-121-08	D-1

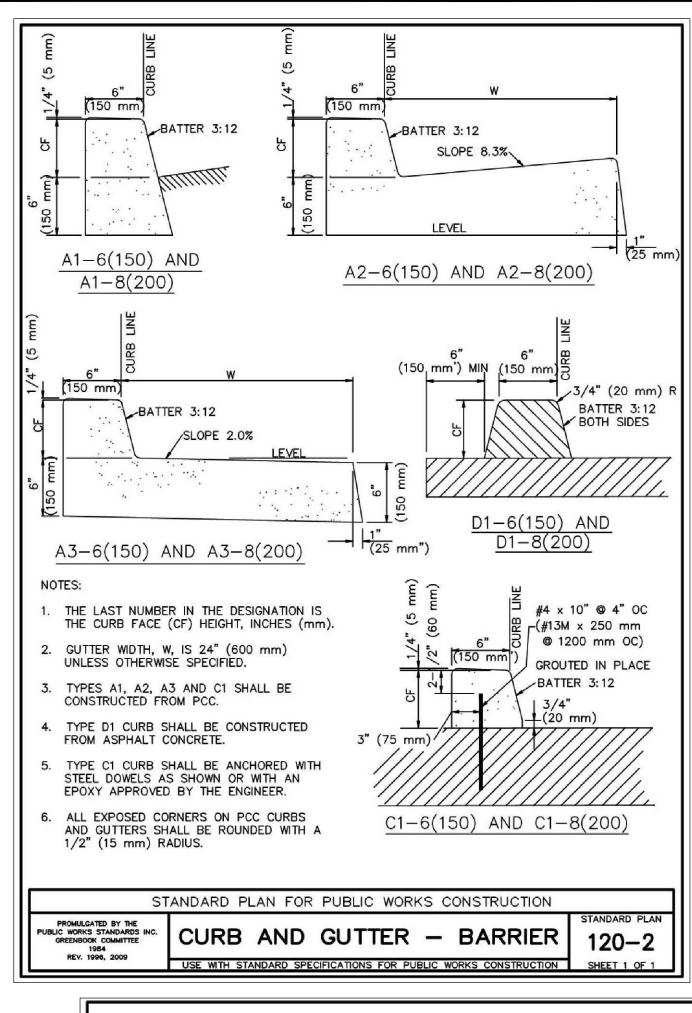

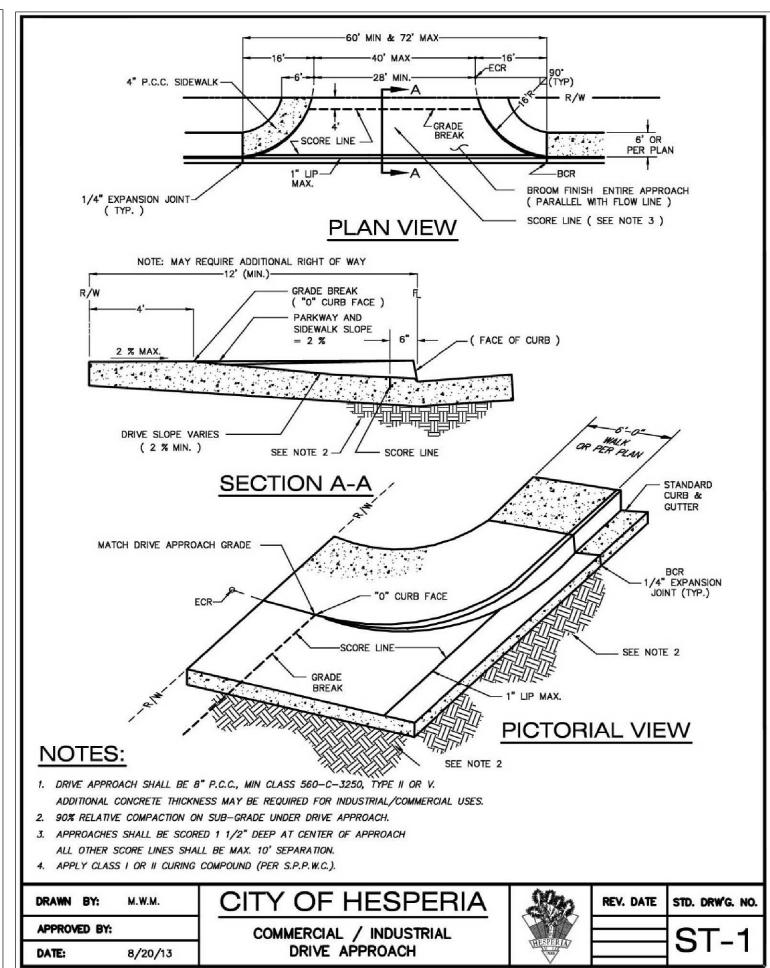


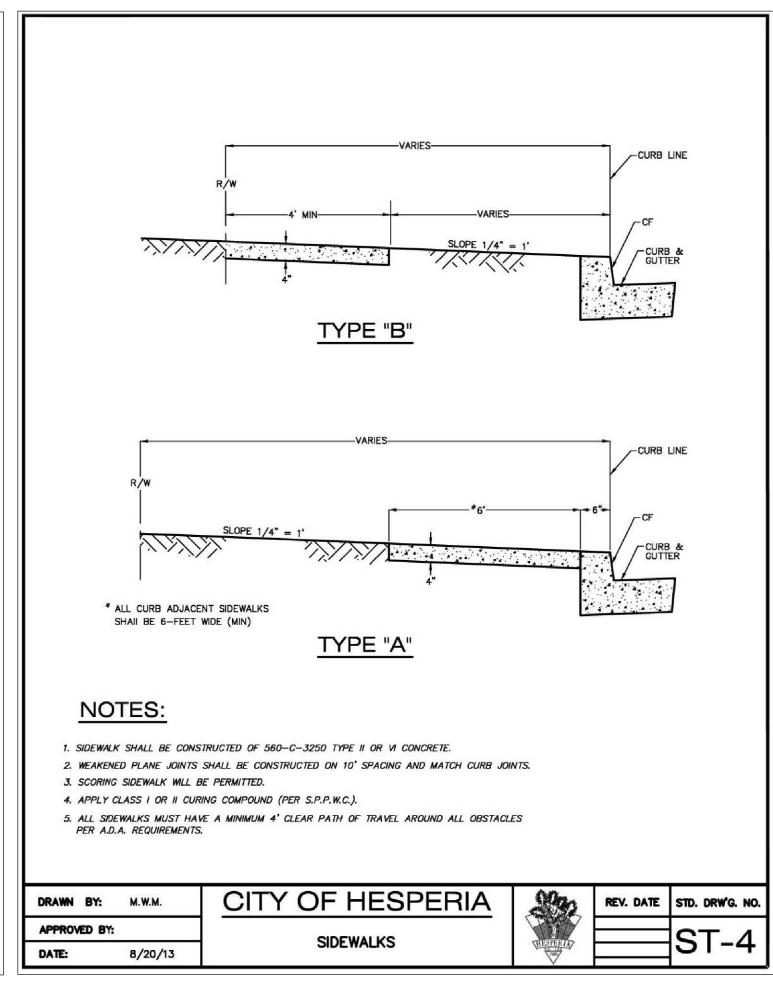


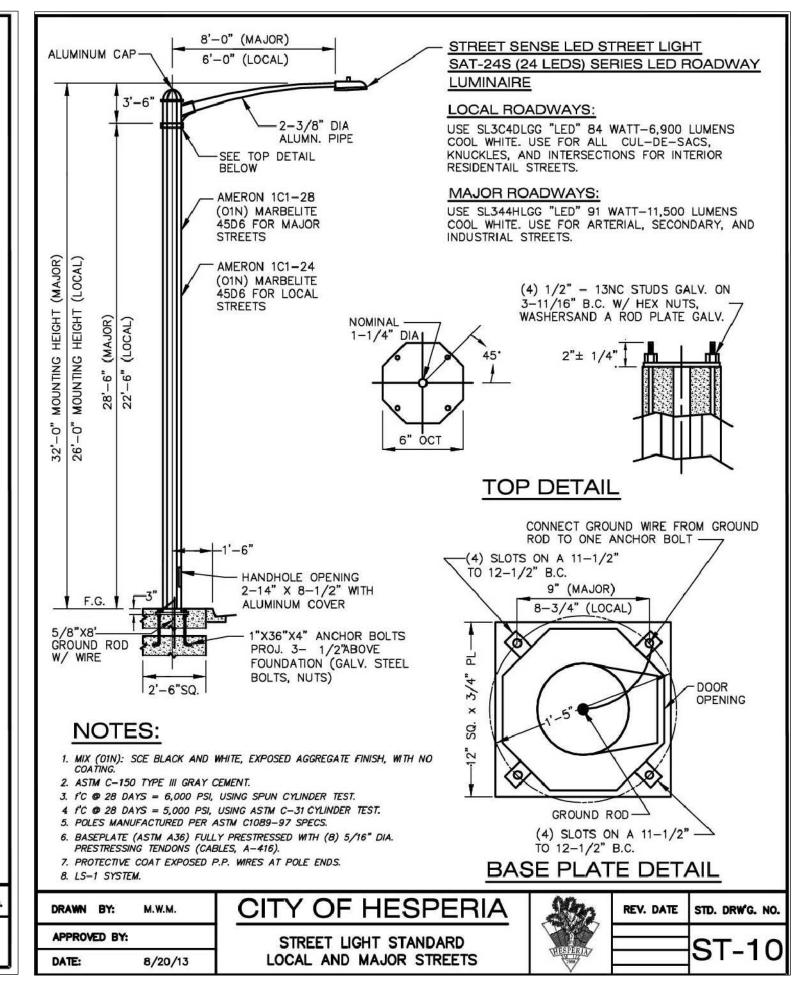

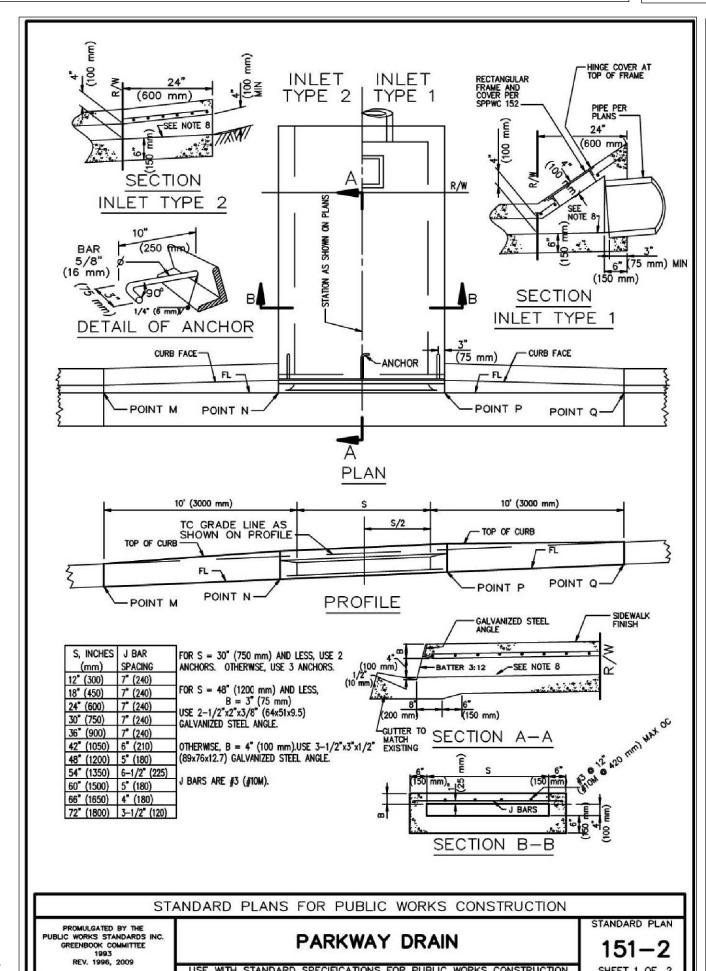


Know what's below.

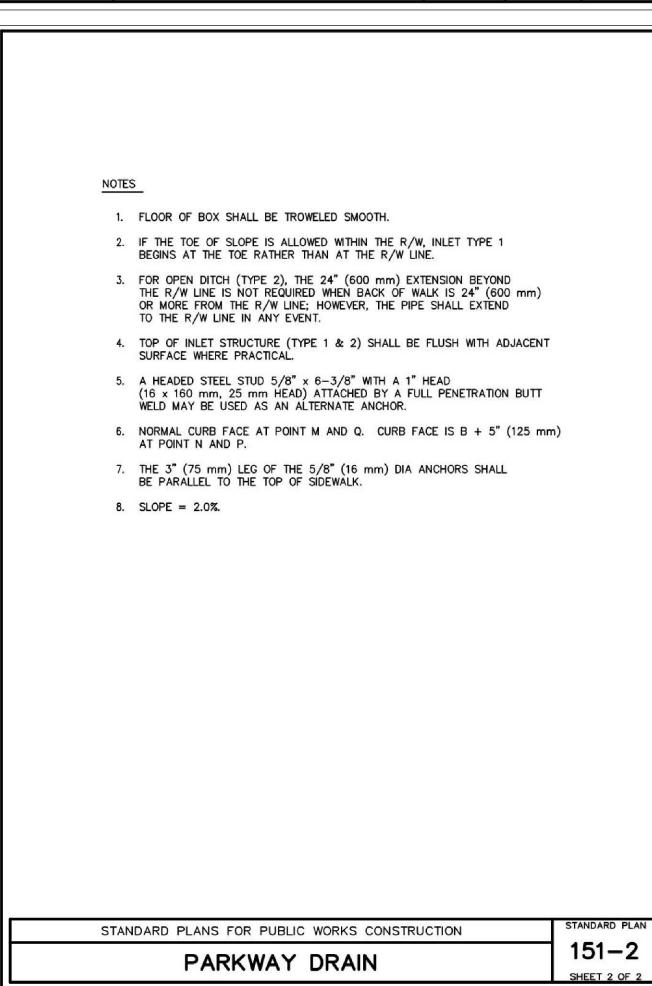

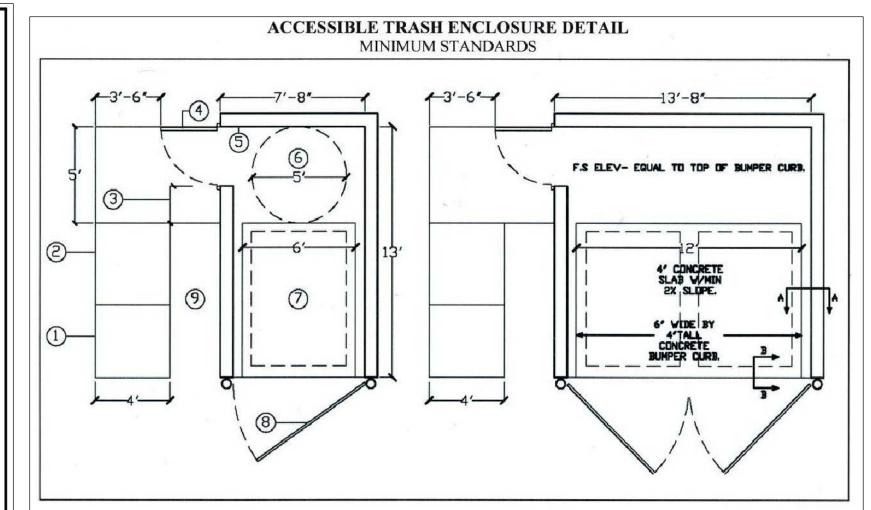


- **KEY NOTES:**
- 1. Landing @ lower level (min. 6' L.)
- 2. Min 48" wide ramp @ max. 1:12 (8.33%) slope.
- 3. Min 2'strike-edge clearance.
- 4. Mesh gate (min. 36" wide w/ 32" clear opening) with accessible door hardware
- 5. Masonry walls shall be constructed of a 6" minimum Precision block with a split face block on the viewable side and with decorative cap. (Earth tone in color & a contrasting decorative cap)
- 6. Wheelchair turning circle (min 60" dia.)
- 7. Trash bins
- 8. Mesh gates
- 9. Area to be landscaped or paved

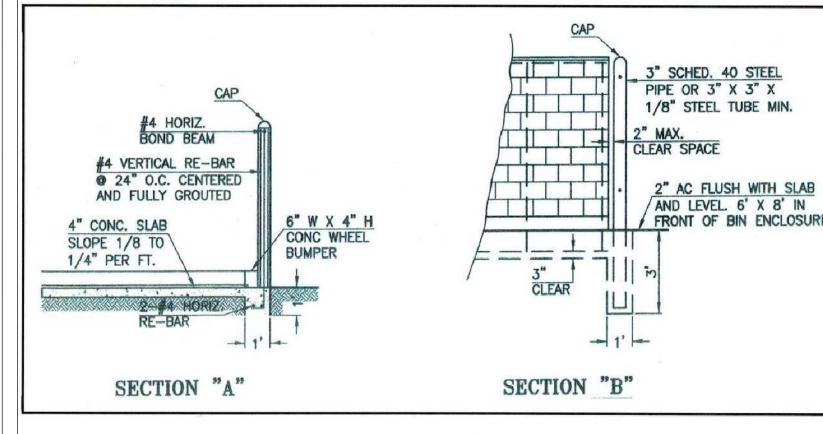

## NOTES:

- 1. Location to be indicated on planning department approval site plan.
- 2. Lap all re-bar splices 24 inches, minimum.
- 3. All cells contacting reinforcing steel are to be solidly grouted.
- 4. Cells required to be grouted are to be in vertical alignment and free from obstruction. Extreme care should be taken when using slump blocking to allow for a clear unobstructed cell.
- 5. Grout to be puddle, rodded or vibrated and consolidated.
- 6. Footing to be dug 12" minimum into undisturbed soil.
- 7. Request inspection for footing and obtain approval prior to pouring.
- 8. Request inspection for wall steel and obtain approval prior to grouting.

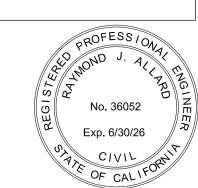

C	all before you dig.				
				BENCHMARK:	DESIGNED BY:D.B.W
				"H-18"	DRAWN BY: D.B.W
				BRASS DISK IN CONCRETE, LOCATED APPROXIMATELY 22 FEET NORTH OF THE NE ECR, BEHIND THE	CHECKED BY: R.J.A.
				SIDEWALK AT THE INTERSECTION OF MAIN ST. & MAPLE ST.	SUBMITTED BY:
REV.	DESCRIPTION	DATE	BY	ELEV=3376.492	RAYMOND J. ALLARD RCE No. 36052 DATE

SHEET 1 OF 2

USE WITH STANDARD SPECIFICATIONS FOR PUBLIC WORKS CONSTRUCTED



## HIGH DESERT MAPPING


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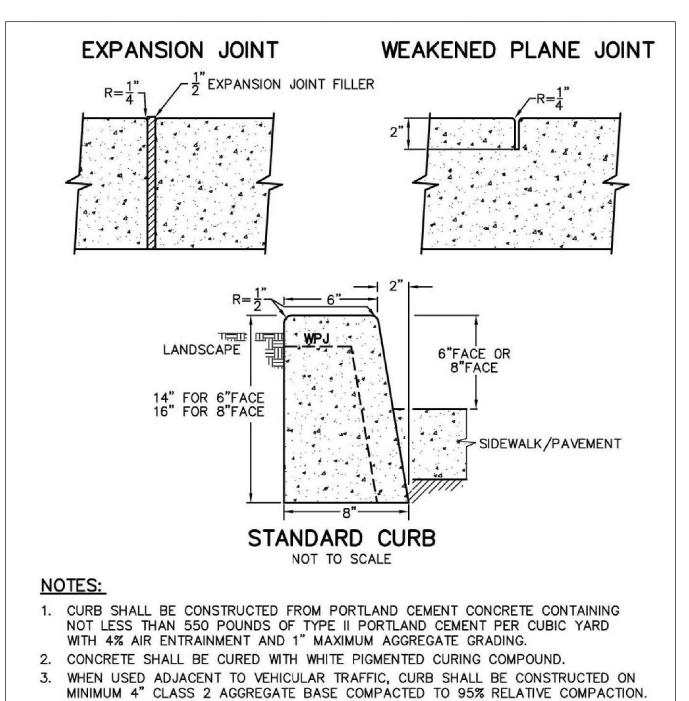
dbw.hdm@gmail.com

CITY OF HESPERIA ENGINEERING DEPARTMENT							
RECOMMENDED FOR APPROVAL BY:	APPROVED BY:						
DATE	CASSANDRA SANCHEZ DATE						
AUTHORIZED SIGNATURE	R.C.E. <u>74776</u> EXP. DATE <u>12/31/25</u> <b>CITY ENGINEER</b>						

CITY OF HESPERIA	
DETAILS	
TAMARISK APARTMENTS	
MUNEM MAIDA	
APN 3057-121-08	

SHEET
9
OF
13
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<b>D-</b> E



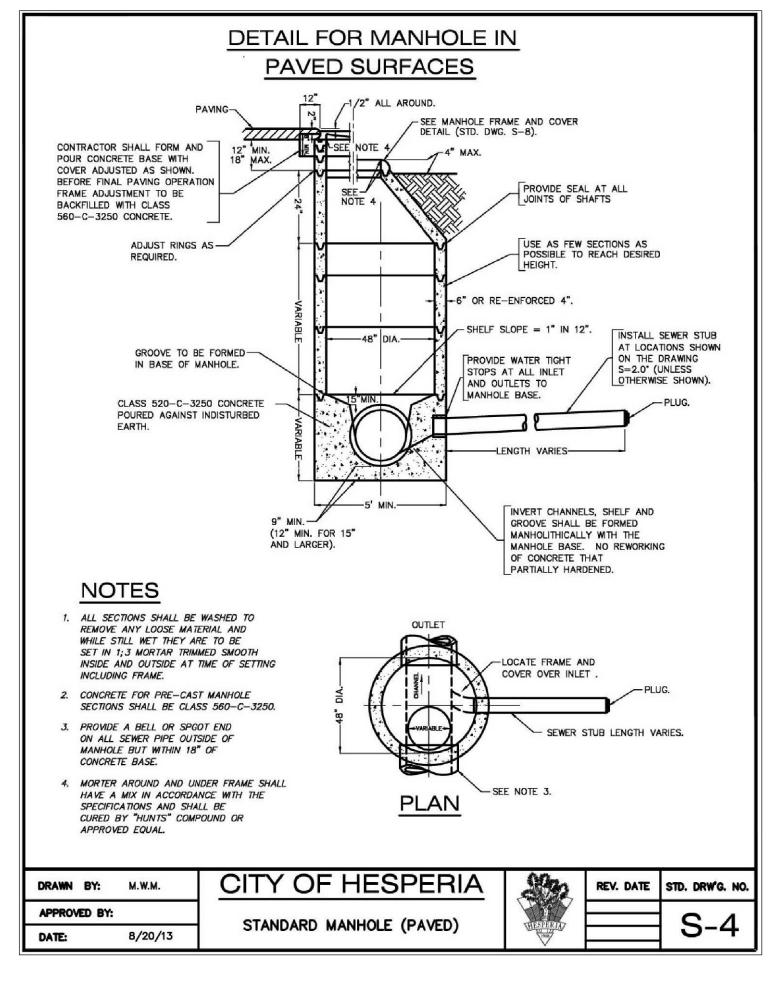

WEAKENED PLANE JOINTS SHALL BE CONSTRUCTED AT 10' INTERVALS.

BE REMOVED TO THE WEAKENED PLANE JOINT OR EXPANSION JOINT.

6. EXPANSION JOINTS SHALL BE CONSTRUCTED AT ALL CURB RETURNS, DRIVEWAY


8. IF EXISTING CURB IS TO BE REMOVED, IT SHALL BE SCORED AT LEAST 1" DEEP WITH A CONCRETE SAW PRIOR TO REMOVAL. IF THE SAWCUT LINE IS CLOSER


EXPANSION JOINTS SHALL BE 1/2" WIDE AND FILLED WITH PLASTIC TYPE FILLERS.


THAN 2' TO A WEAKENED PLANE JOINT OR EXPANSION JOINT, THE CURB SHALL

5. WEAKENED PLANE JOINTS SHALL BE AT LEAST 2" DEEP.


APPROACHES AND AT 60' INTERVALS.

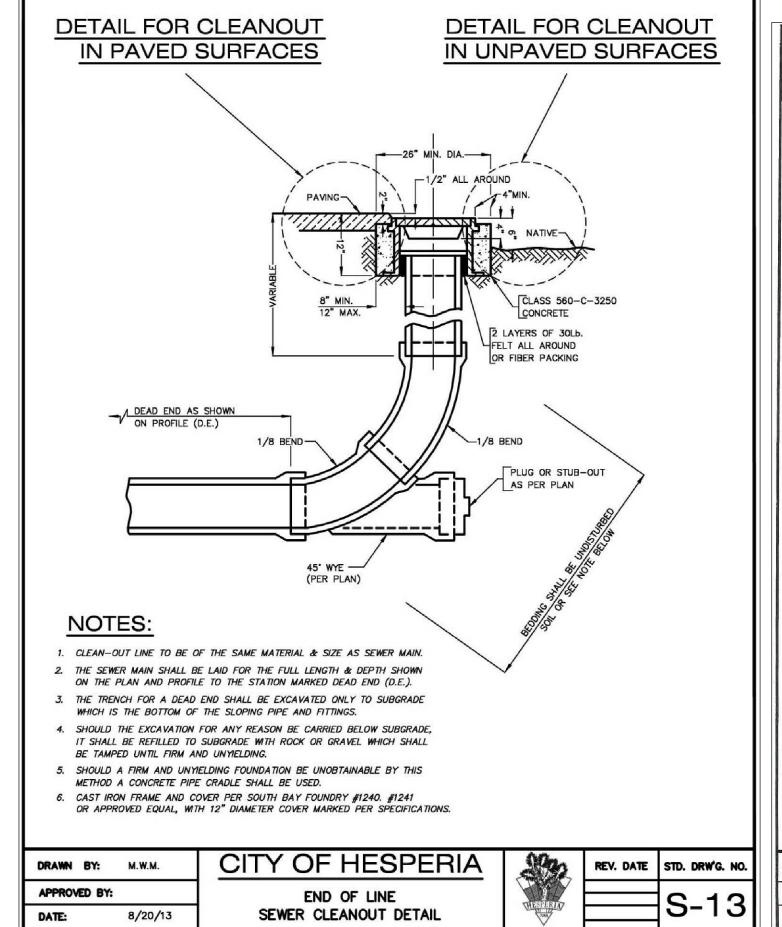


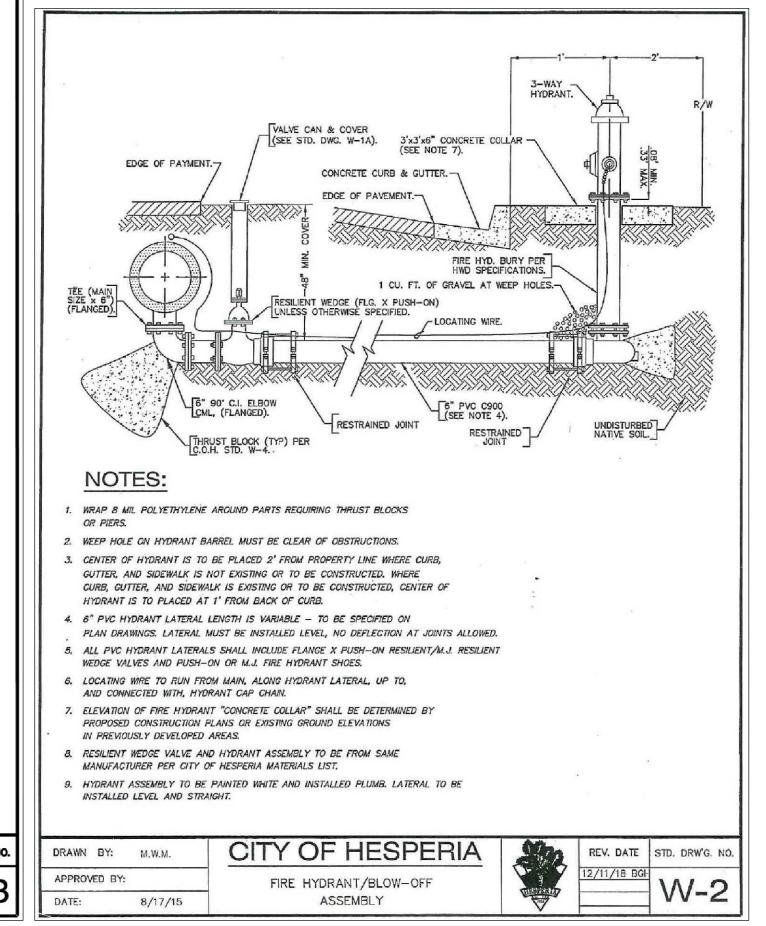

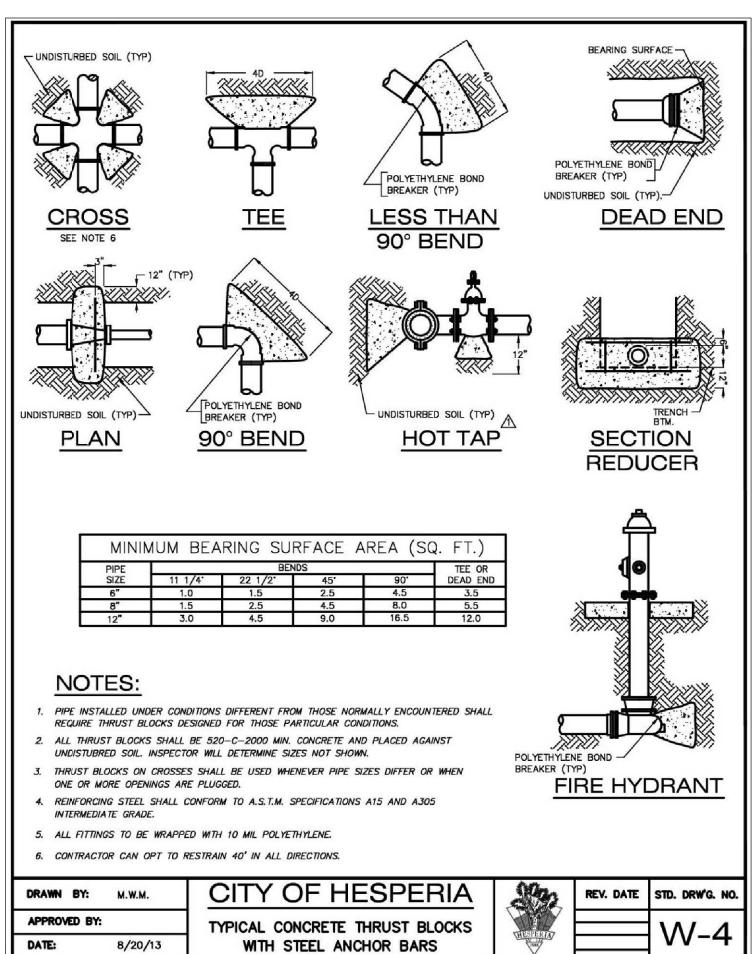


ELEV=3376.492

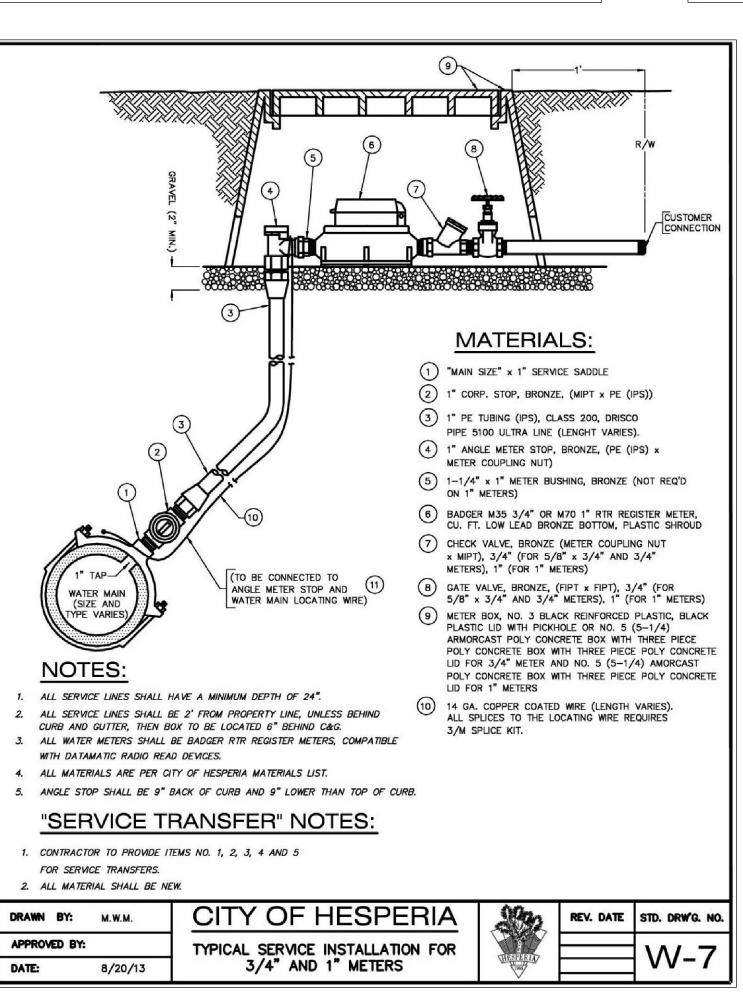

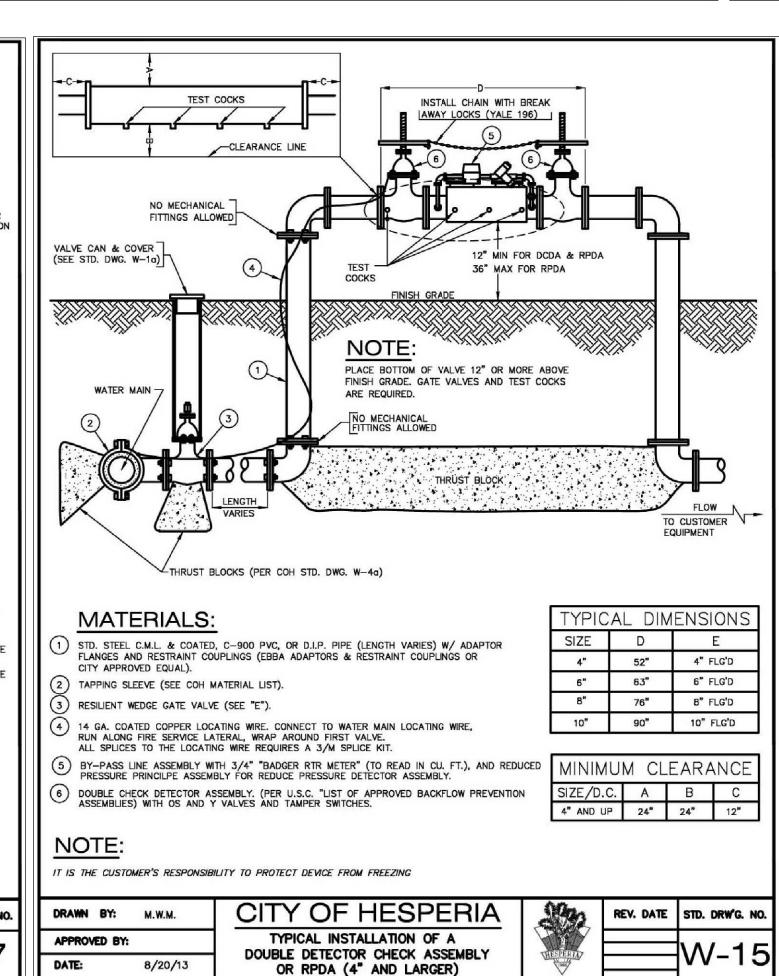

**AUTHORIZED SIGNATURE** 

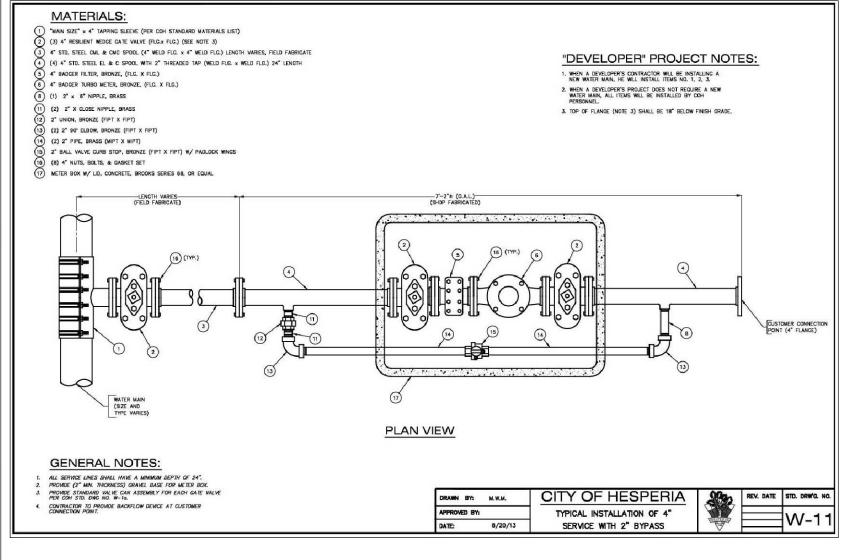



Know what's below. Call before you dig.

DESCRIPTION

**BENCHMARK:** BRASS DISK IN CONCRETE, LOCATED APPROXIMATELY 22 FEET NORTH OF THE NE ECR, BEHIND THE SIDEWALK AT THE INTERSECTION OF MAIN ST. & MAPLE

DATE

DESIGNED BY: D.B.W.

DRAWN BY:

SUBMITTED BY:

D.B.W.

RAYMOND J. ALLARD RCE No. 36052

CHECKED BY: R.J.A.



DATE

HIGH DESERT MAPPING Land Surveying - Civil Design

16704 Neenach Road Apple Valley, CA 92307 (760) 508-8555

dbw.hdm@gmail.com

	HESPERIA 3 DEPARTMENT
RECOMMENDED FOR APPROVAL BY:	APPROVED BY:
DATE	CASSANDRA SANCHEZ DATE

R.C.E. <u>74776</u> EXP. DATE <u>12/31/25</u>


**CITY ENGINEER** 

**CITY OF HESPERIA DETAILS** TAMARISK APARTMENTS **MUNEM MAIDA** APN 3057-121-08

SHEET 10  $\mathbf{OF}$ 13 **D-3** 

No. 36052

Exp. 6/30/26

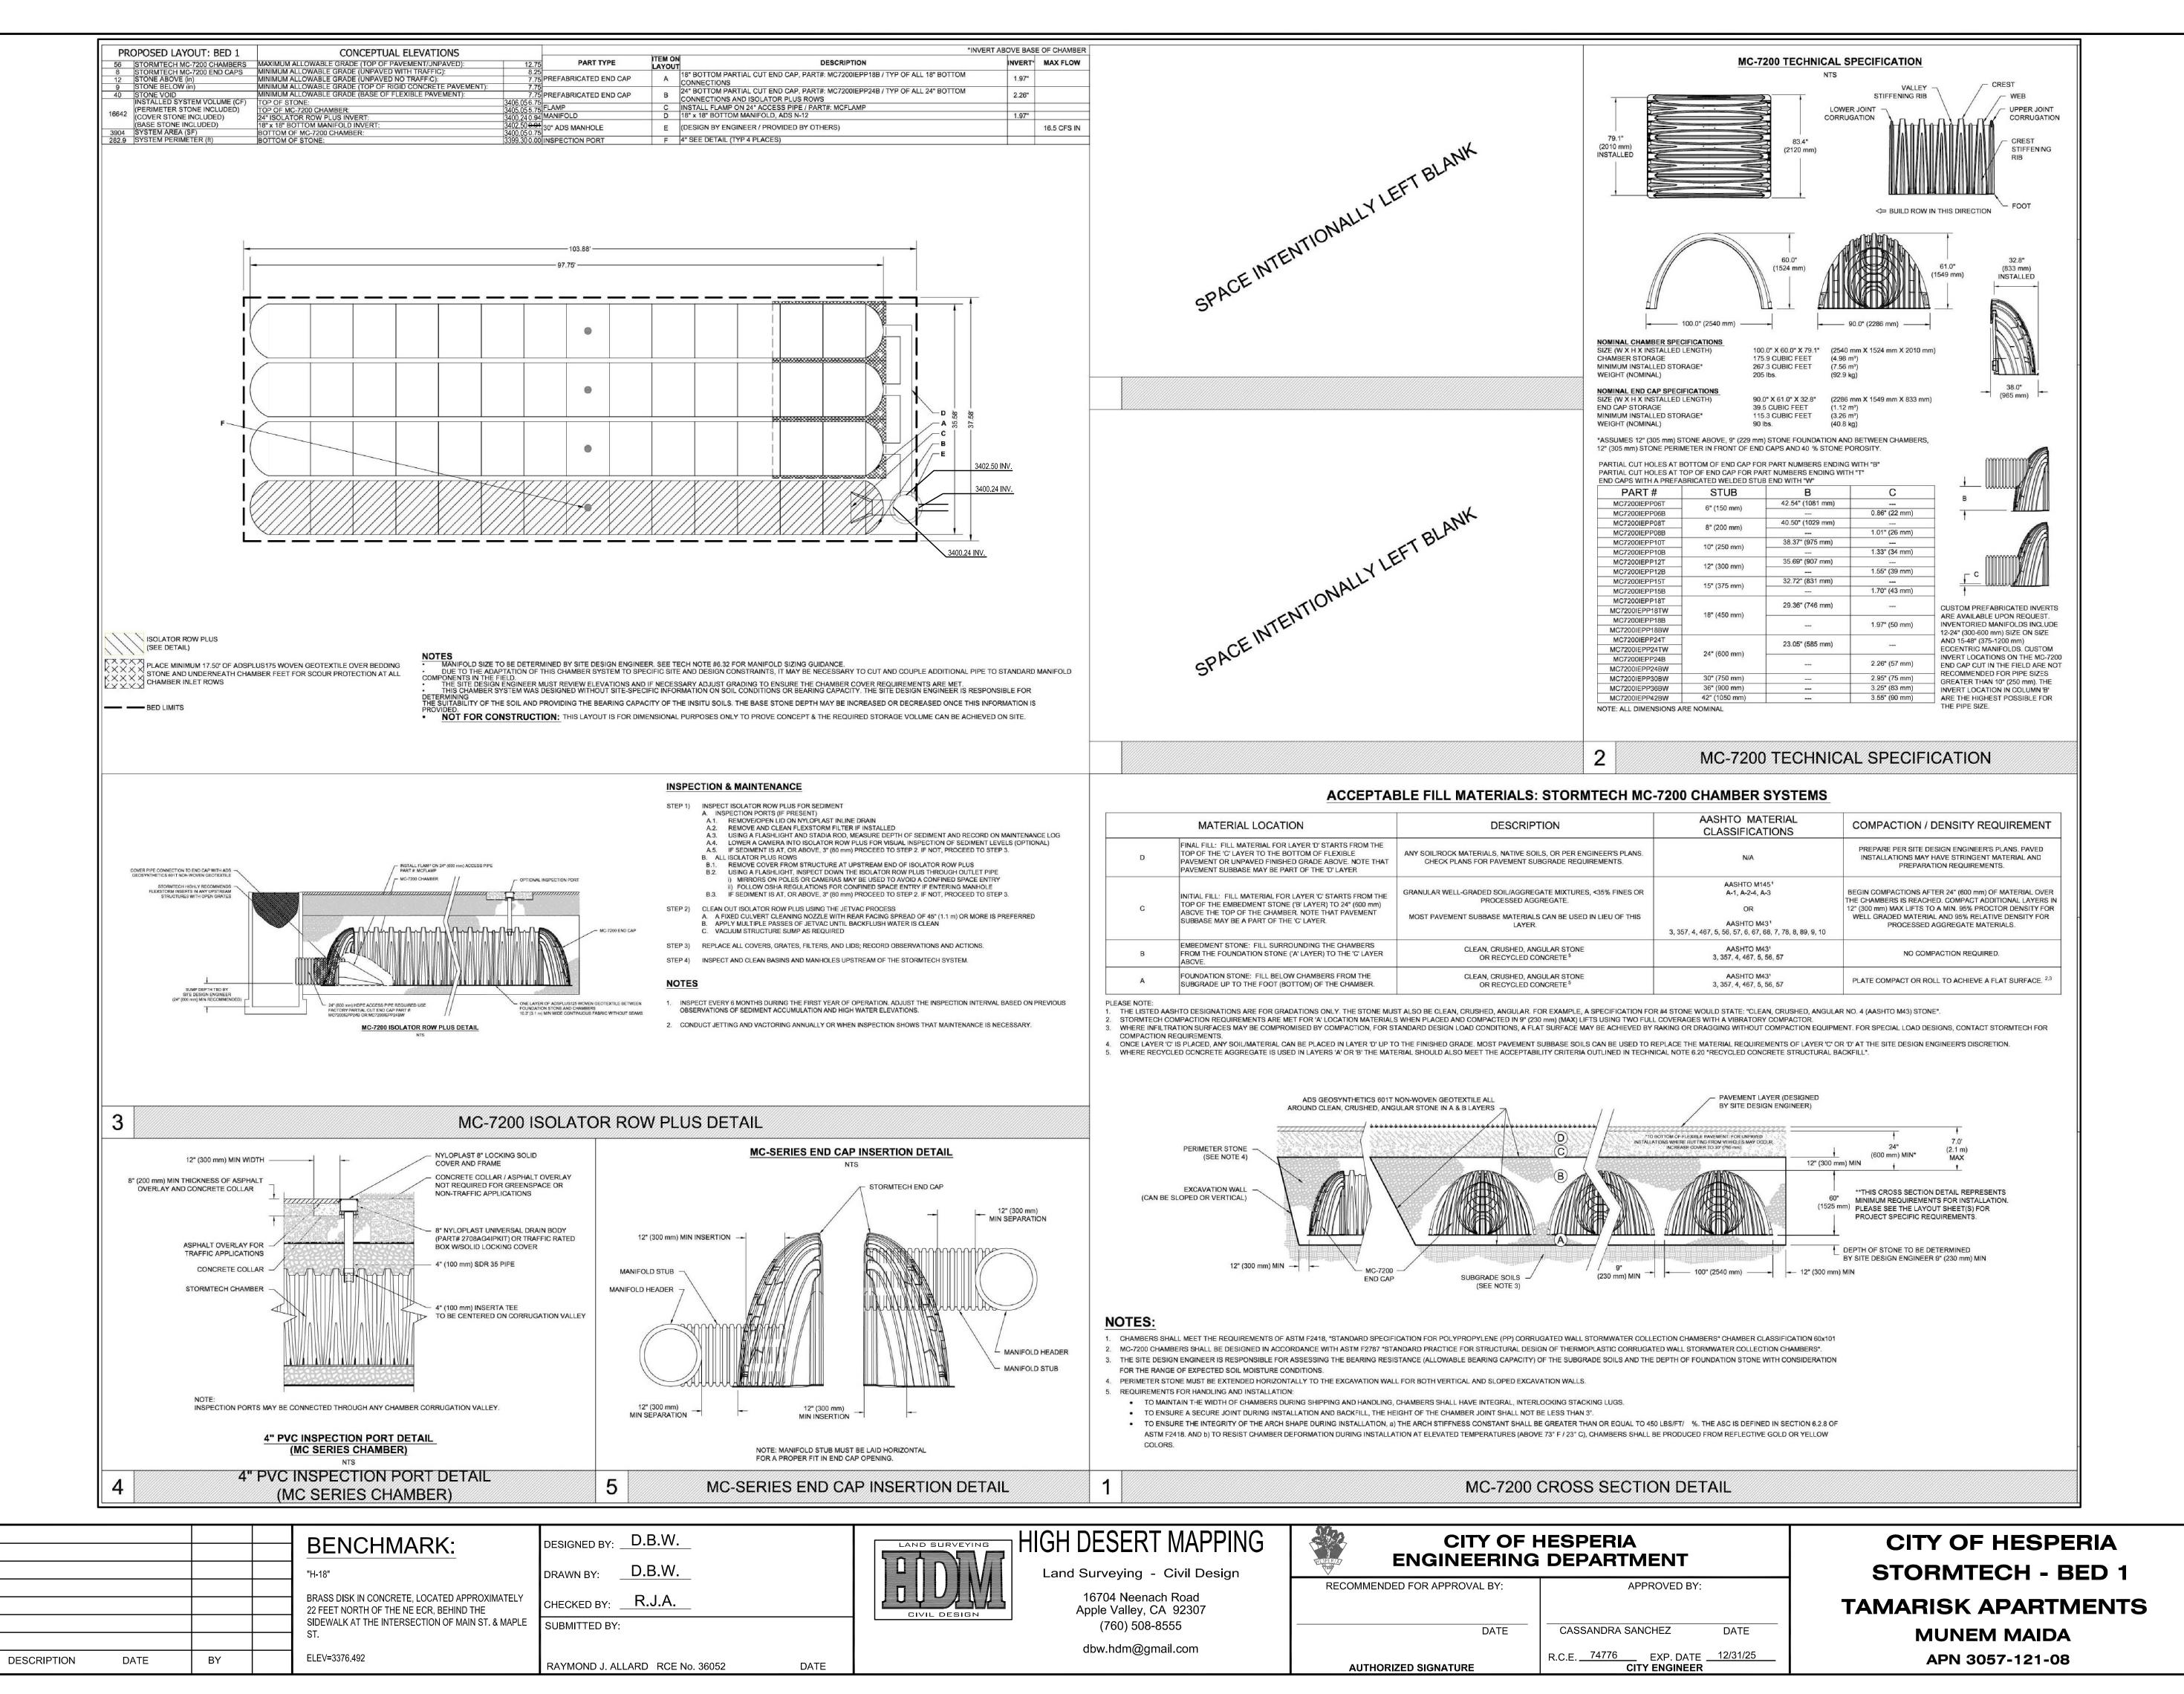

SHEET


11

OF

13

No. 36052

Exp. 6/30/26

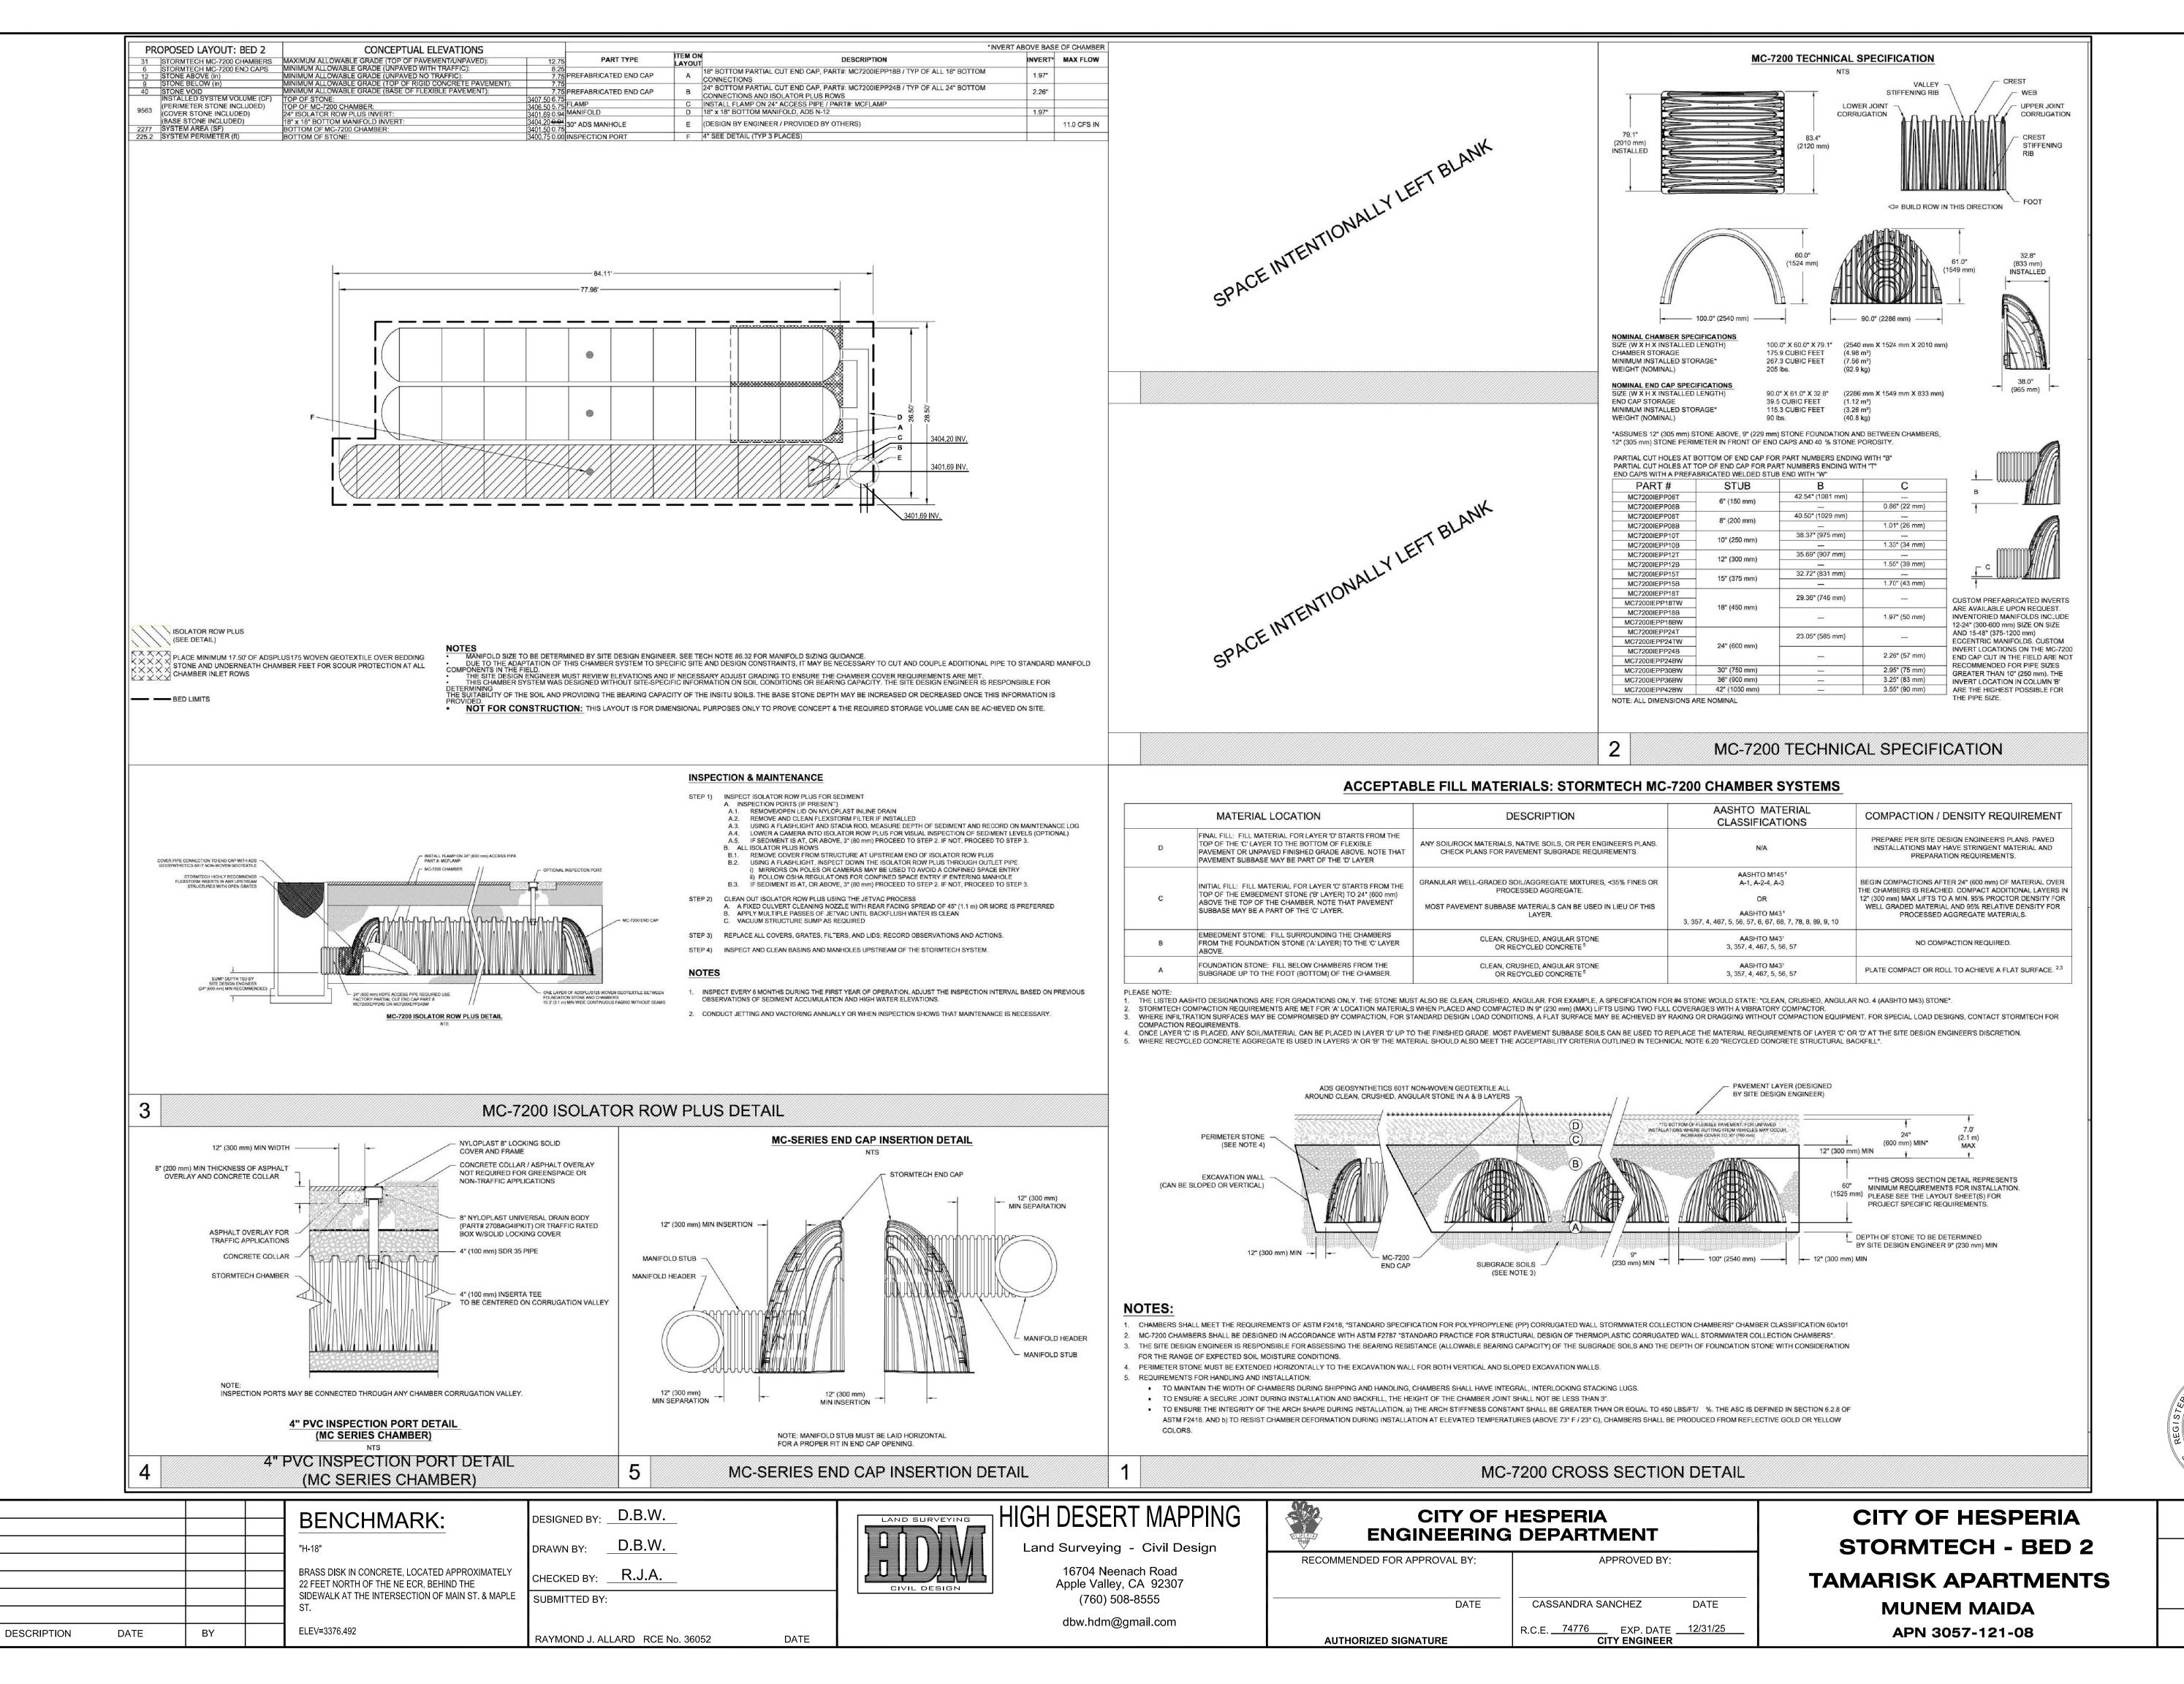

SHEET

12

OF

13

**SD-2** 

No. 36052

Exp. 6/30/26

